
# PRELIMINARY EROSION CONTROL PLANS

FOR

# TAELOR SOLAR PHASE 1

LOCATED IN

MORGAN COUNTY, COLORADO

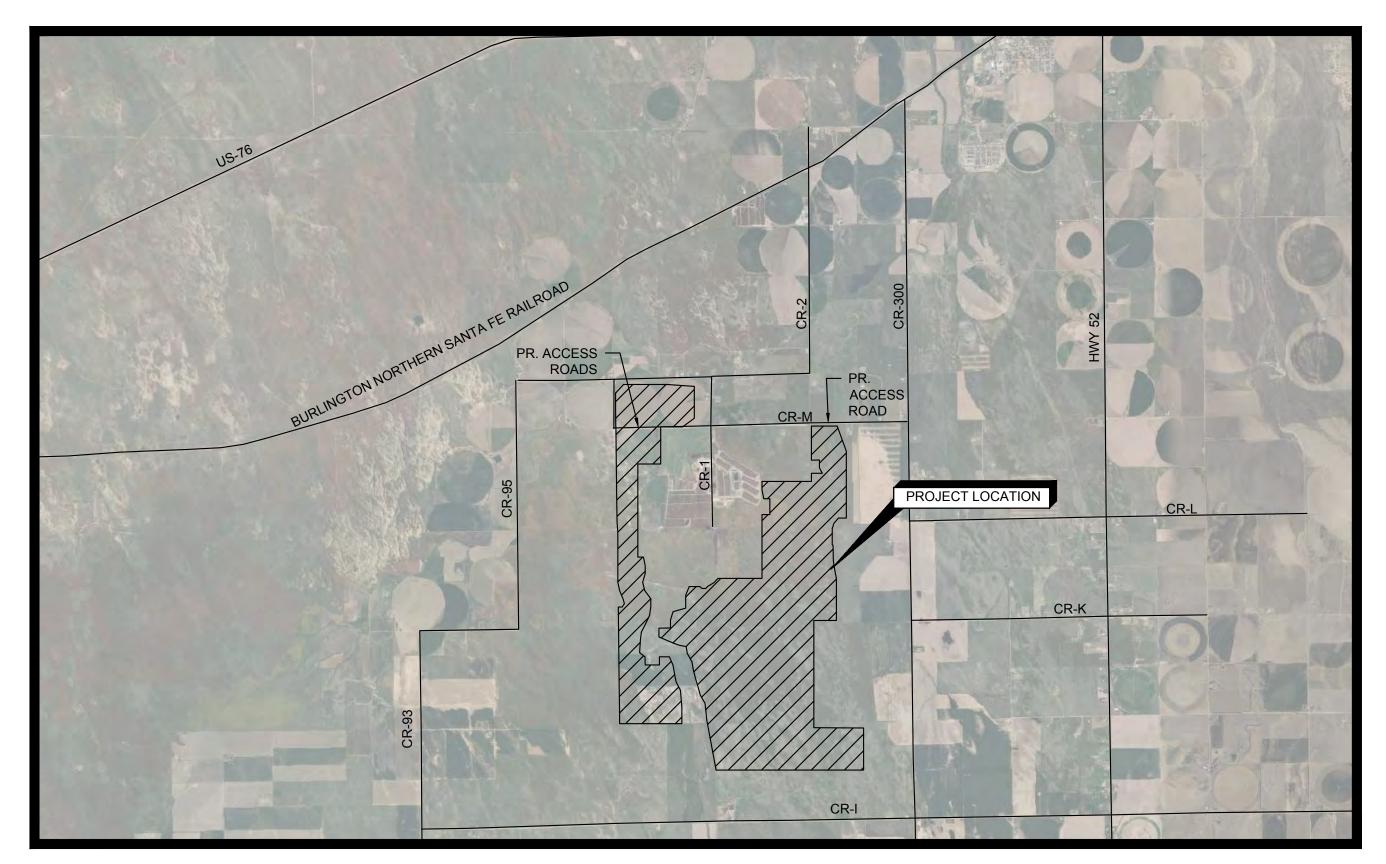

SHEE	T LIST TABLE
SHEET NUMBER	SHEET TITLE
ECO.O	COVER
EC0.1	GENERAL NOTES
EC1.0	OVERALL EROSION CONTROL PLAN
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EC1.4	EROSION CONTROL PLAN
EC1.5	EROSION CONTROL PLAN
EC1.6	EROSION CONTROL PLAN
EC2.0	EROSION CONTROL DETAILS

### SURVEY NOTE

COORDINATE SYSTEM: HORIZONTAL DATUM:

NAD 83 (2011 ADJ)

#### FEMA FLOOD ZONE NOTE:

A PORTION OF THE PROPERTY LIES WITHIN TYPE A FLOOD ZONE (100 YEAR FLOOD HAZARD WITH NO DEFINED BASE FLOOD ELEVATION) PER FLOOD MAP PANELS 08087C0550D AND 08087C0575D (4/4/2018). FEMA ZONE A IS OUTSIDE THE BUILDABLE LIMITS OF THIS PROJECT.



#### PROJECT INFORMATION

PROJECT NAME:

SITE ADDRESS:

TOTAL DEVELOPMENT AREA:

EXISTING ZONING:

PROPOSED USE:

TAELOR SOLAR PHASE 1

MORGAN COUNTY, CO

3,133 AC

AGRICULTURAL

SOLAR COLLECTOR FACI

MORGAN COUNTY, CO 3,133 AC AGRICULTURAL SOLAR COLLECTOR FACILITY, AGRICULTURAL ZONE

#### PROJECT TEAM

OWNER
BALANCED ROCK POWER
310 E 100 S
MOAB, UT 84532
CONTACT: LIAM NORRIS
PHONE: (480) 544-3919

CIVIL ENGINEER

KIMLEY-HORN AND ASSOCIATES, INC.
6200 SOUTH SYRACUSE WAY, SUITE 300
GREENWOOD VILLAGE, CO 80111
CONTACT: ERIK STROCK
PHONE: (303) 226-6805

COLORADO 81
KNOW WHAT'S BELOW, CALL BEFORE YOU DIG.



© 2023 KIMLEY-HORN AND 6200 SOUTH SYRACUSE VICENWOOD VILLAGE CC (303) 228-2

SHEET NUMBER

ECO.0

#### GENERAL EROSION CONTROL NOTES

- 1. BMPS ARE SHOWN SCHEMATICALLY HEREON; FOR PRECISE LOCATION REFER TO DETAILS OR CONSULT ENGINEER.
- 2. CONTRACTOR SHALL PROVIDE, MAINTAIN, AND INDICATE ON THIS PLAN
- A. VEHICLE WASH AREAB. CONTAINER AND MATERIALS STORAGE AREA
- C. FUELING AREA
- D. STOCKPILE LOCATIONS
- E. SANITARY AREA
- F. VEHICLE AND EQUIPMENT MAINTENANCE
- G. OTHER APPROPRIATE BEST MANAGEMENT PRACTICES)
- H. SECONDARY CONTAINMENT FOR POTENTIAL SPILLS3. PRIOR TO WORK, SITE VEGETATION IS 65%.
- 4. THIS PLAN SHEET SHOULD BE UPDATED AS NEEDED BY THE CONTRACTOR TO PROPERLY ACCOMMODATE FIELD CONDITIONS DETERMINED ON SITE AND THROUGHOUT CONSTRUCTION ACTIVITIES.
- SITE AND THROUGHOUT CONSTRUCTION ACTIVITIES.

  5. CONTRACTOR IS SOLELY RESPONSIBLE FOR IMPLEMENTATION, AND MAINTENANCE OF ALL SWMP CONTROLS.
- 6. CONTRACTOR IS SOLELY RESPONSIBLE FOR IMPLEMENTATION, AND MAINTENANCE OF ALL SWMP CONTROLS.

  6. CONTRACTOR SHALL RECORD INSTALLATION, MAINTENANCE OR MODIFICATION, AND REMOVAL DATES FOR EACH BMP EMPLOYED (WHETHER
- CALLED OUT ON ORIGINAL SWMP OR NOT) DIRECTLY ON THIS SITE MAP.

  7. DRAINAGE PATTERNS ARE SHOWN ON THIS PLAN BY EXISTING CONTOURS.
- 8. TEMPORARY AND PERMANENT STABILIZATION PRACTICES AND BMP'S SHALL BE INSTALLED AT THE EARLIEST POSSIBLE TIME DURING THE CONSTRUCTION SEQUENCE.
- 9. CONSTRUCTION ENTRANCE SHALL BE LOCATED SO AS TO PROVIDE THE LEAST AMOUNT OF DISTURBANCE TO THE FLOW OF TRAFFIC IN AND
- OUT OF THE SITE.

  10. CONTRACTOR IS RESPONSIBLE FOR MODIFYING THE SWMP/SITE MAP TO INCLUDE BMP'S FOR ANY OFF-SITE MATERIAL WASTE, BORROW OR
- EQUIPMENT STORAGE AREAS.

  11. CONTRACTOR IS RESPONSIBLE FOR SUBMITTAL OF NOI, NOT, POSTING OF SITE NOTICES, AND ANY ADDITIONAL INFORMATION OR SUBMITTALS REQUIRED BY COLORADO DEPARTMENT OF HEALTH AND ENVIRONMENT, EPA, OR LOCAL JURISDICTION.
- 12. CONTRACTOR SHALL TEMPORARILY STABILIZE AREAS OF DISTURBANCE WITHIN 7 DAYS AFTER THE COMPLETION OF CONSTRUCTION ACTIVITIES IF AN AREA IS TO LIE DORMANT LONGER THAN 14 DAYS. TEMPORARY STABILIZATION MEASURES INCLUDE BUT ARE NOT LIMITED TO: EROSION CONTROL BLANKET, SILT FENCE, ADDITIONAL TEMPORARY SEEDING, AND/OR ADDITIONAL MEASURES AS APPROVED BY THE ENGINEER.
- 13. CONTRACTOR SHALL MONITOR LOCAL WEATHER FORECASTS AND HAVE ENHANCED BMP MEASURES INSTALLED PRIOR TO ANY QUALIFYING STORM EVENT.
- 14. WHERE SILT FENCE AND EARTH DIKE ARE INSTALLED ADJACENT TO ONE ANOTHER, SILT FENCE SHALL OVERLAP EARTH DIKE A MINIMUM OF 10 FEFT.
- 15. CONTRACTOR SHALL HAVE ADDITIONAL BMPs STOCKPILED ON SITE IN PREPARATION FOR POTENTIAL STORM EVENTS. CONTRACTOR SHALL MONITOR WEATHER PATTERNS AND ENSURE SITE IS PROPERLY STABILIZED WITH APPROPRIATE BMP MEASURES PRIOR TO ANY STORM EVENT.
- 16. CONTRACTOR SHALL PRESERVE VEGETATION OUTSIDE OF THE LIMITS OF DISTURBANCE AND SHALL ALLOW VEGETATION WITHIN DISTURBED AREAS TO GROW BACK POST-CONSTRUCTION.


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	DESIGNED BY KLG	S P	6200 SOUTH SYRACUSE WAY, SUITE 300	POWER	2	REVISION 2	07/26/2023	
	DRAWN BY KLG	, (c)	GREENWOOD VILLAGE COLORADO 80111		~	REVISION 1	06/16/2023	
	\ \ \ \ \ \ \ \ \ \ \ \ \ \ \ \ \ \ \	Q	(303) 228-2300			CINCIONAG		


GENERAL NOTES


AELOR SOLAR PHASE 1

SHEET NUMBER

ECO.1

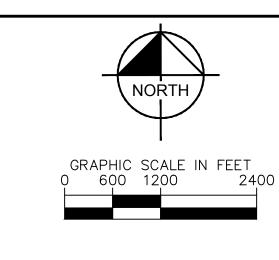

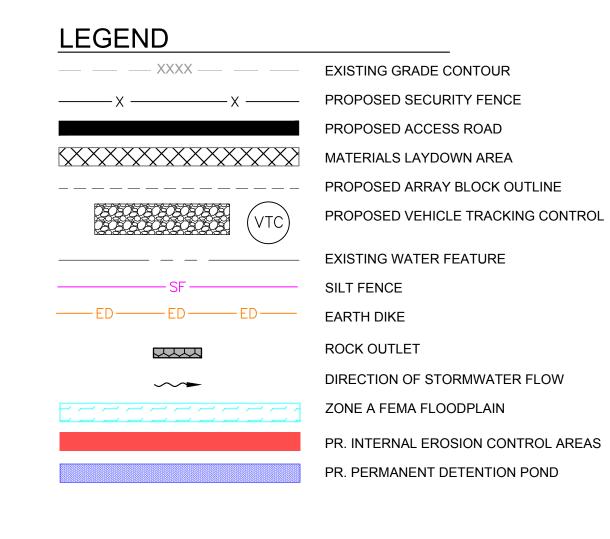


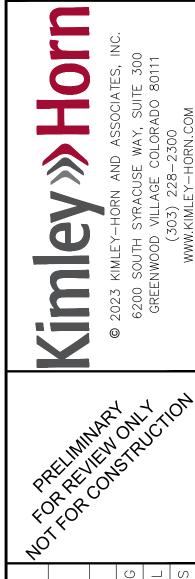


OVERALL EROSION CONTROL PLAN

SHEET NUMBER


EC1.0

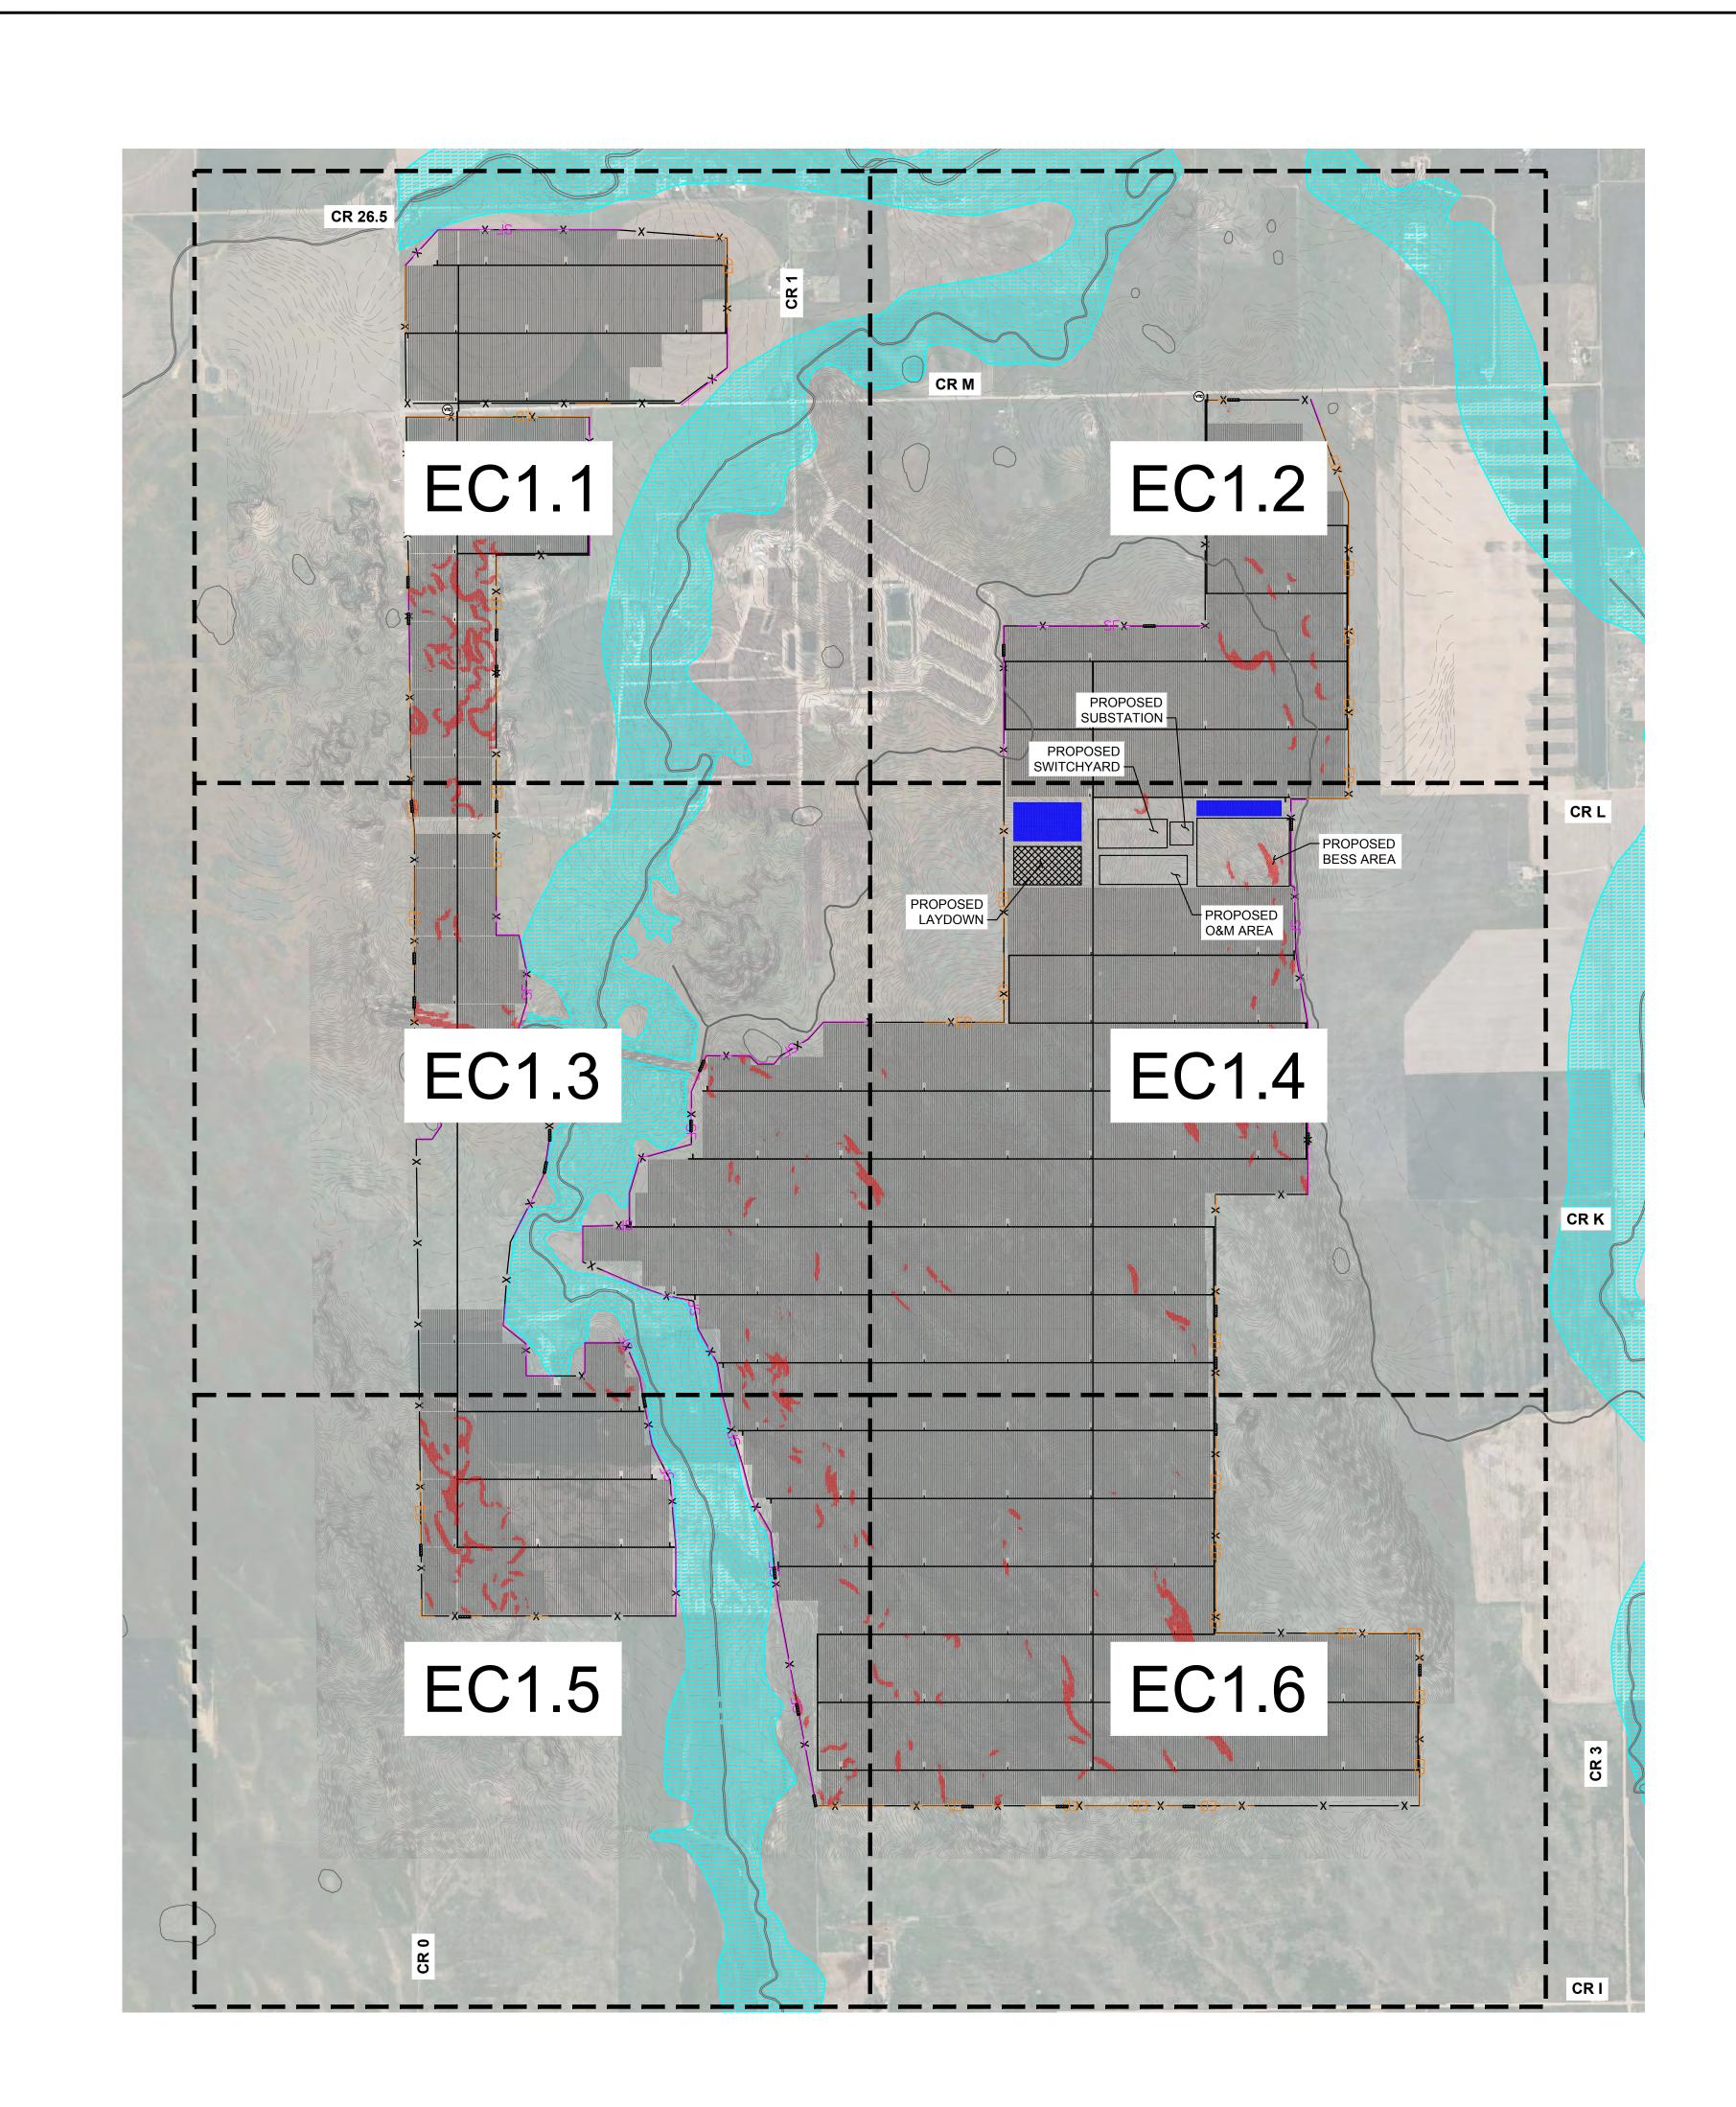


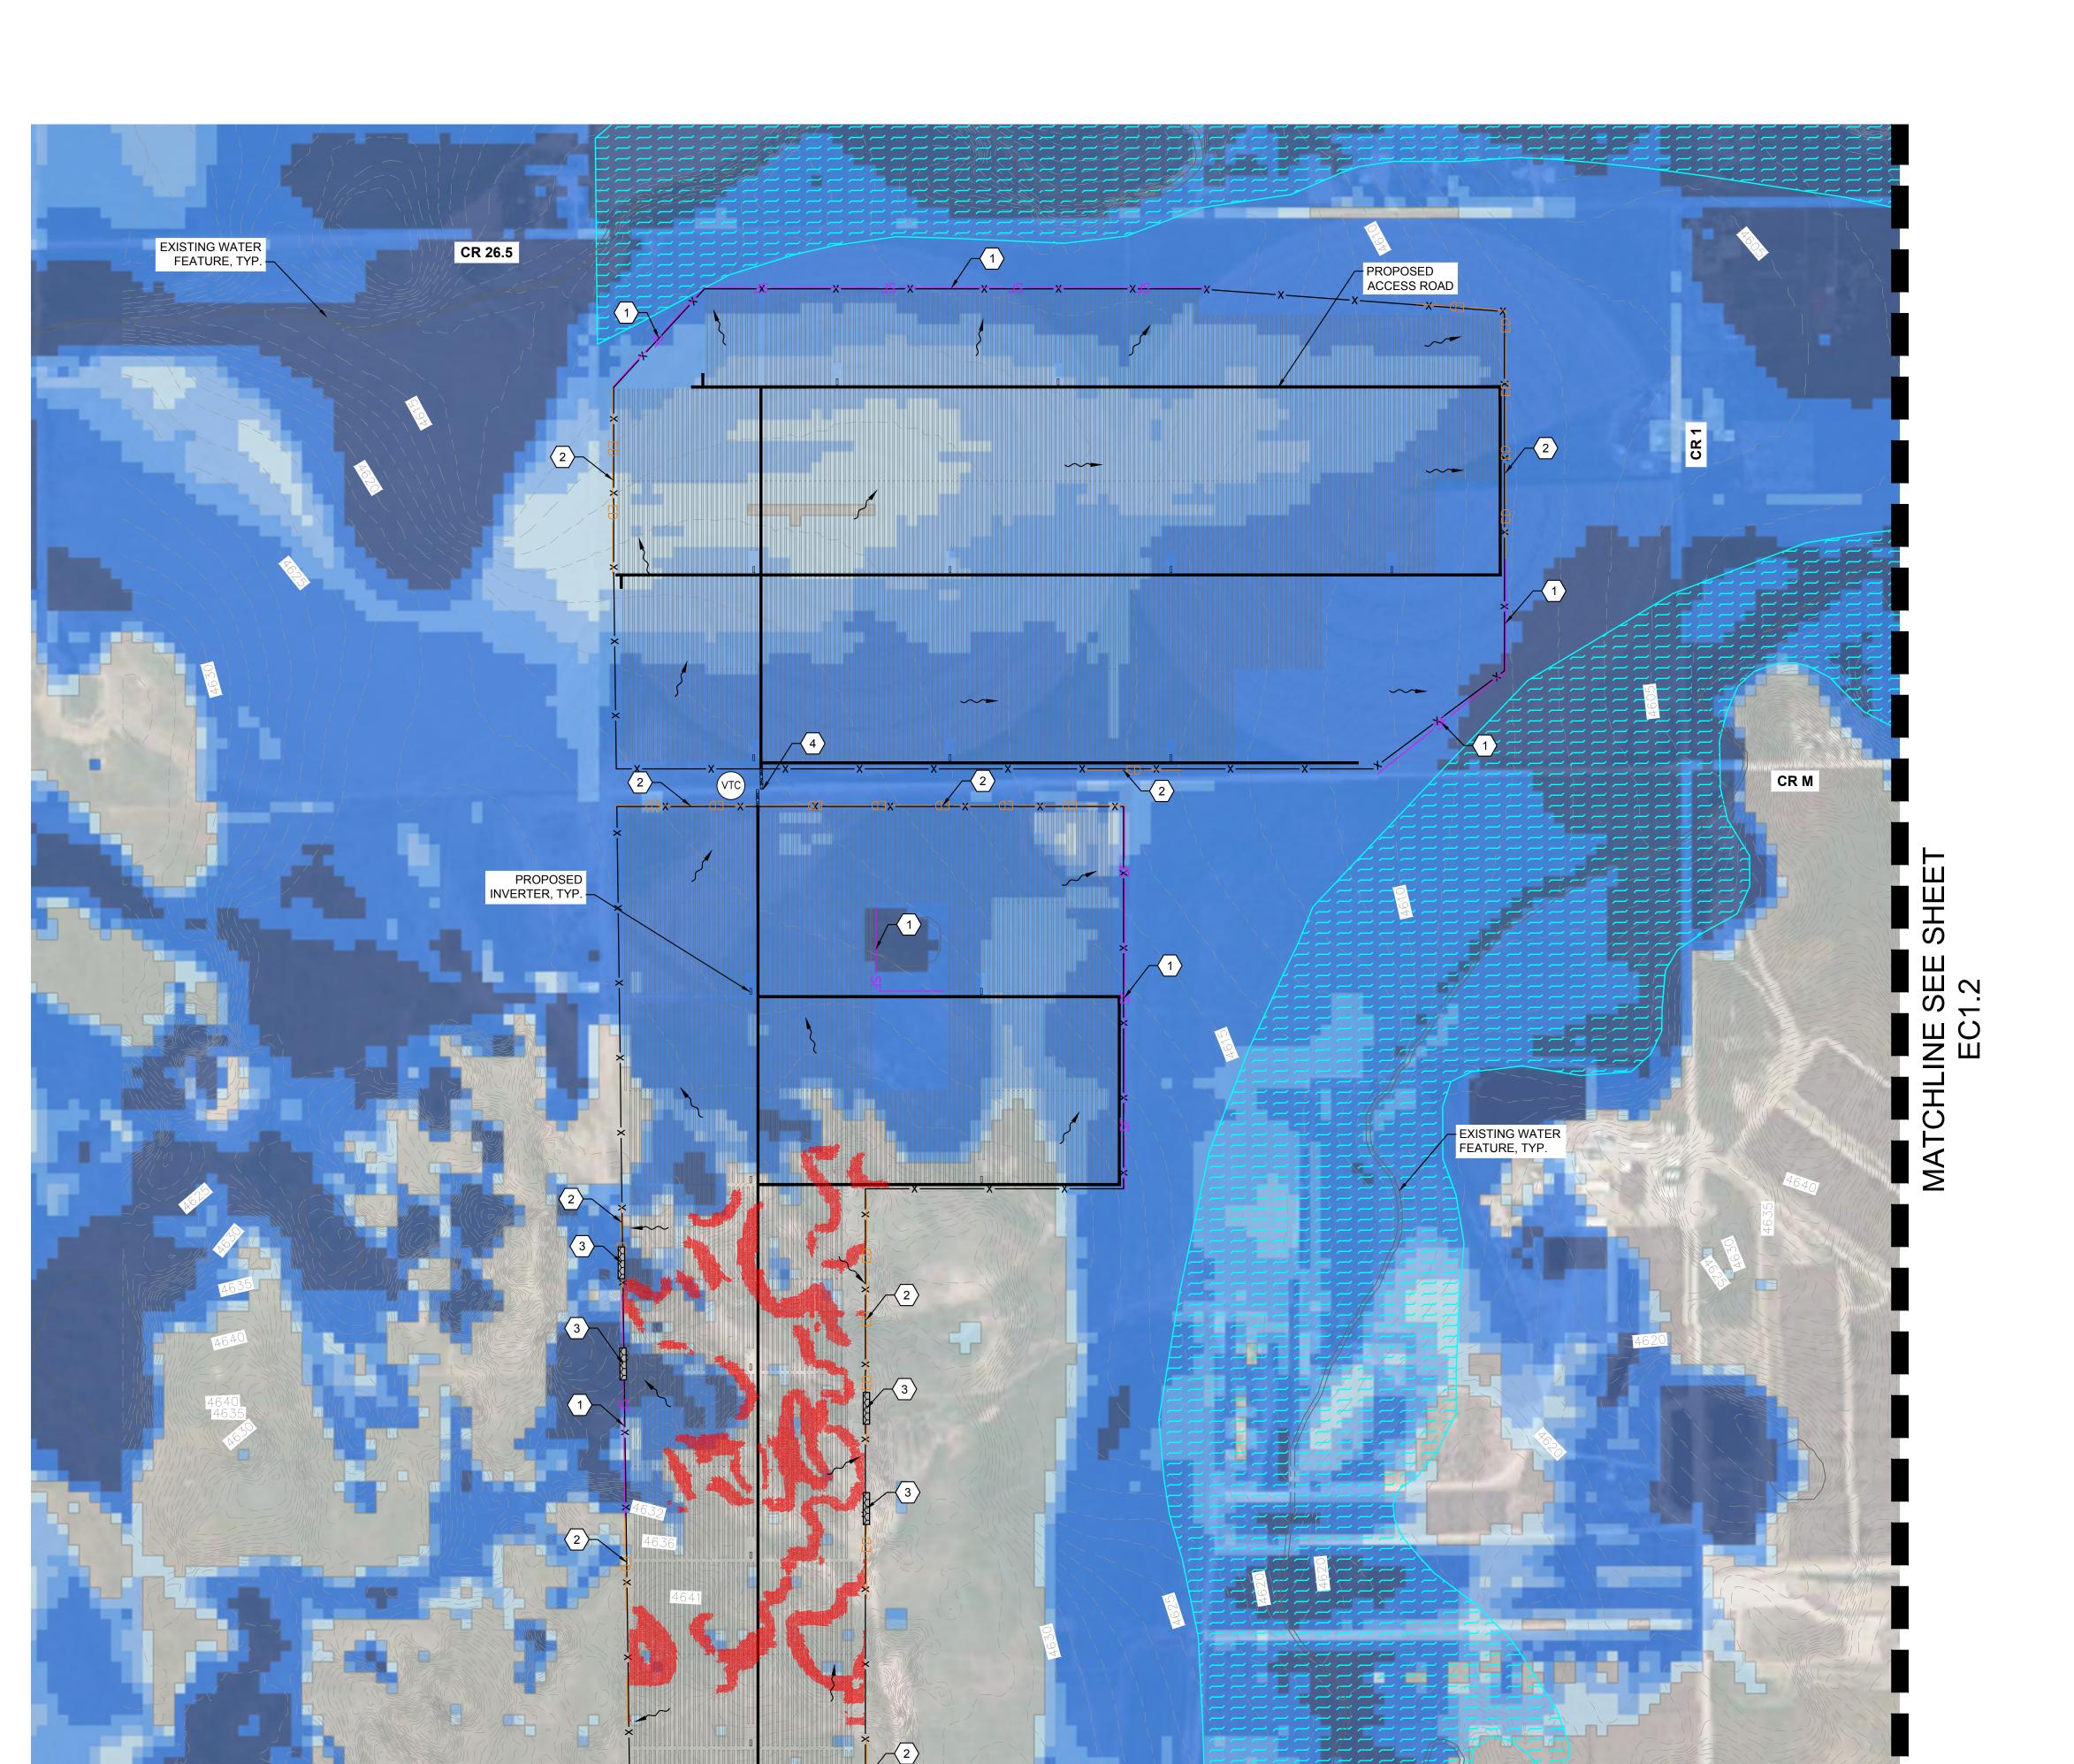

MATCHLINE SEE SHEET

EC1.3

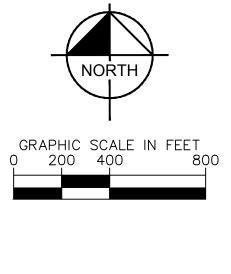

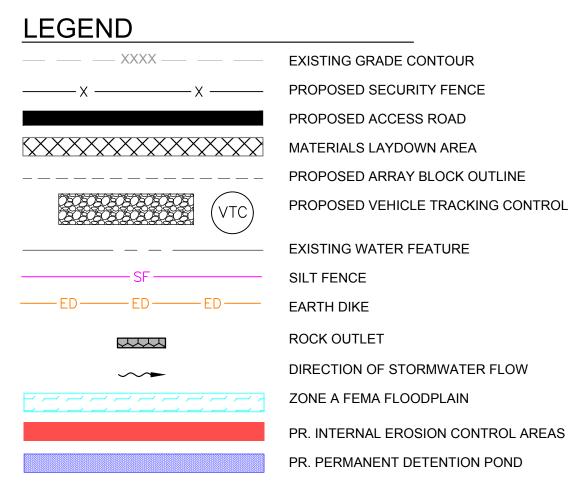

#### **EROSION CONTROL NOTES**

- 1 INSTALL SILT FENCE, SEE DETAIL 1, SHEET EC2.0
- 2 INSTALL EARTH DIKE, SEE DETAIL 2, SHEET EC2.0
- 3 INSTALL ROCK OUTLET SEE DETAIL 3, SHEET EC2.0
- 4 CONSTRUCTION ENTRANCE, SEE DETAIL 6, SHEET EC2.0

#### PROVIDED FLOOD DEPTH AND SCOUR (FT)


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FLOOD DEPTH (1.00 - 1.50)

FLOOD DEPTH (1.50 - 2.00)

FLOOD DEPTH (2.01 - 4.00)

FLOOD DEPTH (4.01+)




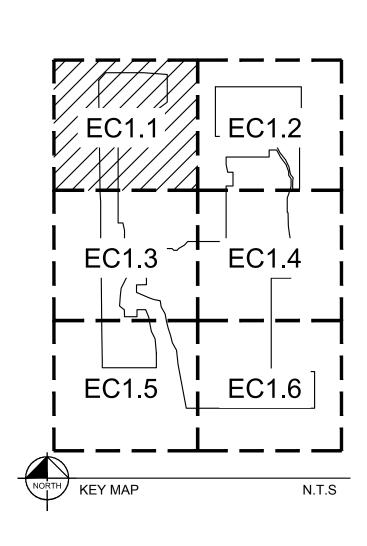


TAELOR SO PHASE ' FACILITY

Or

SHEET NUMBER EC1.1

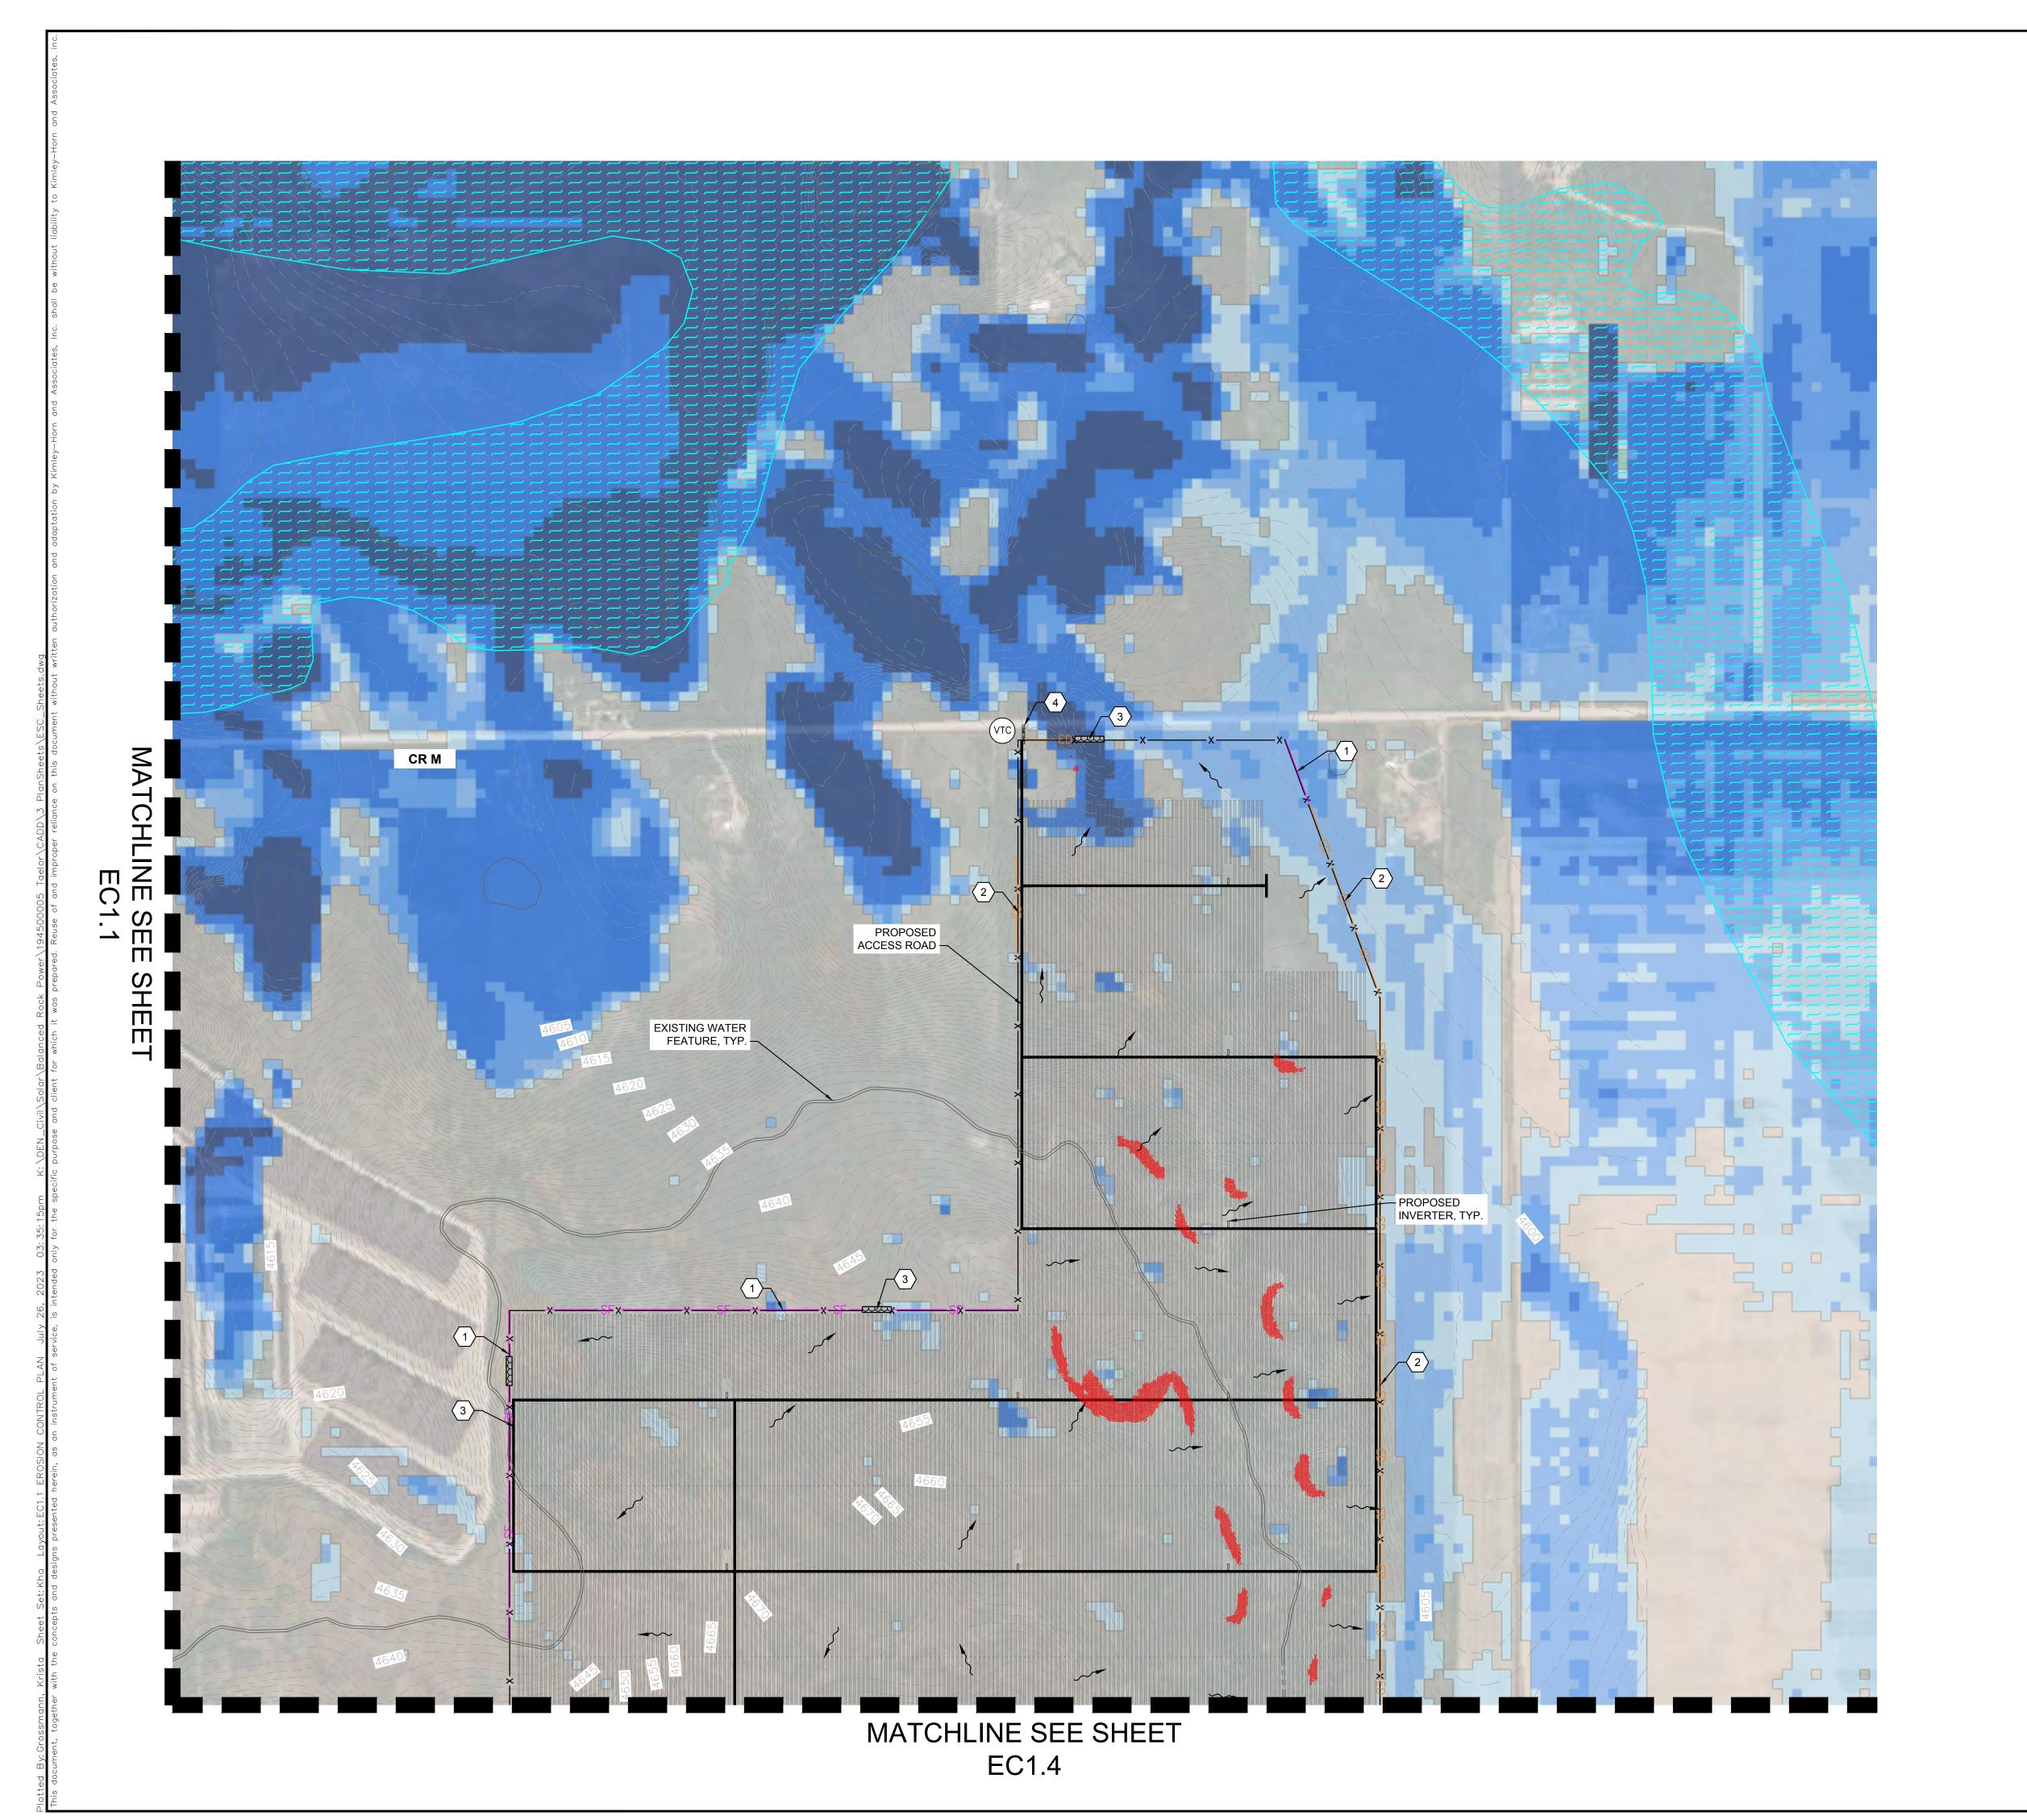

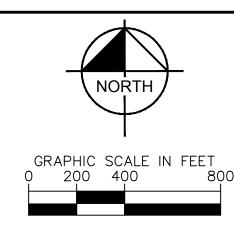


LEGEND EXISTING GRADE CONTOUR PROPOSED SECURITY FENCE PROPOSED ACCESS ROAD MATERIALS LAYDOWN AREA PROPOSED ARRAY BLOCK OUTLINE PROPOSED VEHICLE TRACKING CONTROL EXISTING WATER FEATURE SILT FENCE EARTH DIKE ROCK OUTLET DIRECTION OF STORMWATER FLOW ZONE A FEMA FLOODPLAIN PR. INTERNAL EROSION CONTROL AREAS PR. PERMANENT DETENTION POND

### **EROSION CONTROL NOTES**

- 1 INSTALL SILT FENCE, SEE DETAIL 1, SHEET EC2.0
- 2 INSTALL EARTH DIKE, SEE DETAIL 2, SHEET EC2.0
- 3 INSTALL ROCK OUTLET SEE DETAIL 3, SHEET EC2.0
- 4 CONSTRUCTION ENTRANCE, SEE DETAIL 6, SHEET EC2.0

#### PROVIDED FLOOD DEPTH AND SCOUR (FT)


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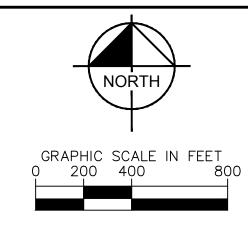


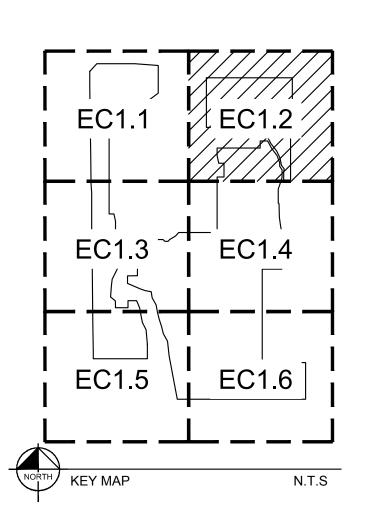

SHEET NUMBER EC1.2

Or



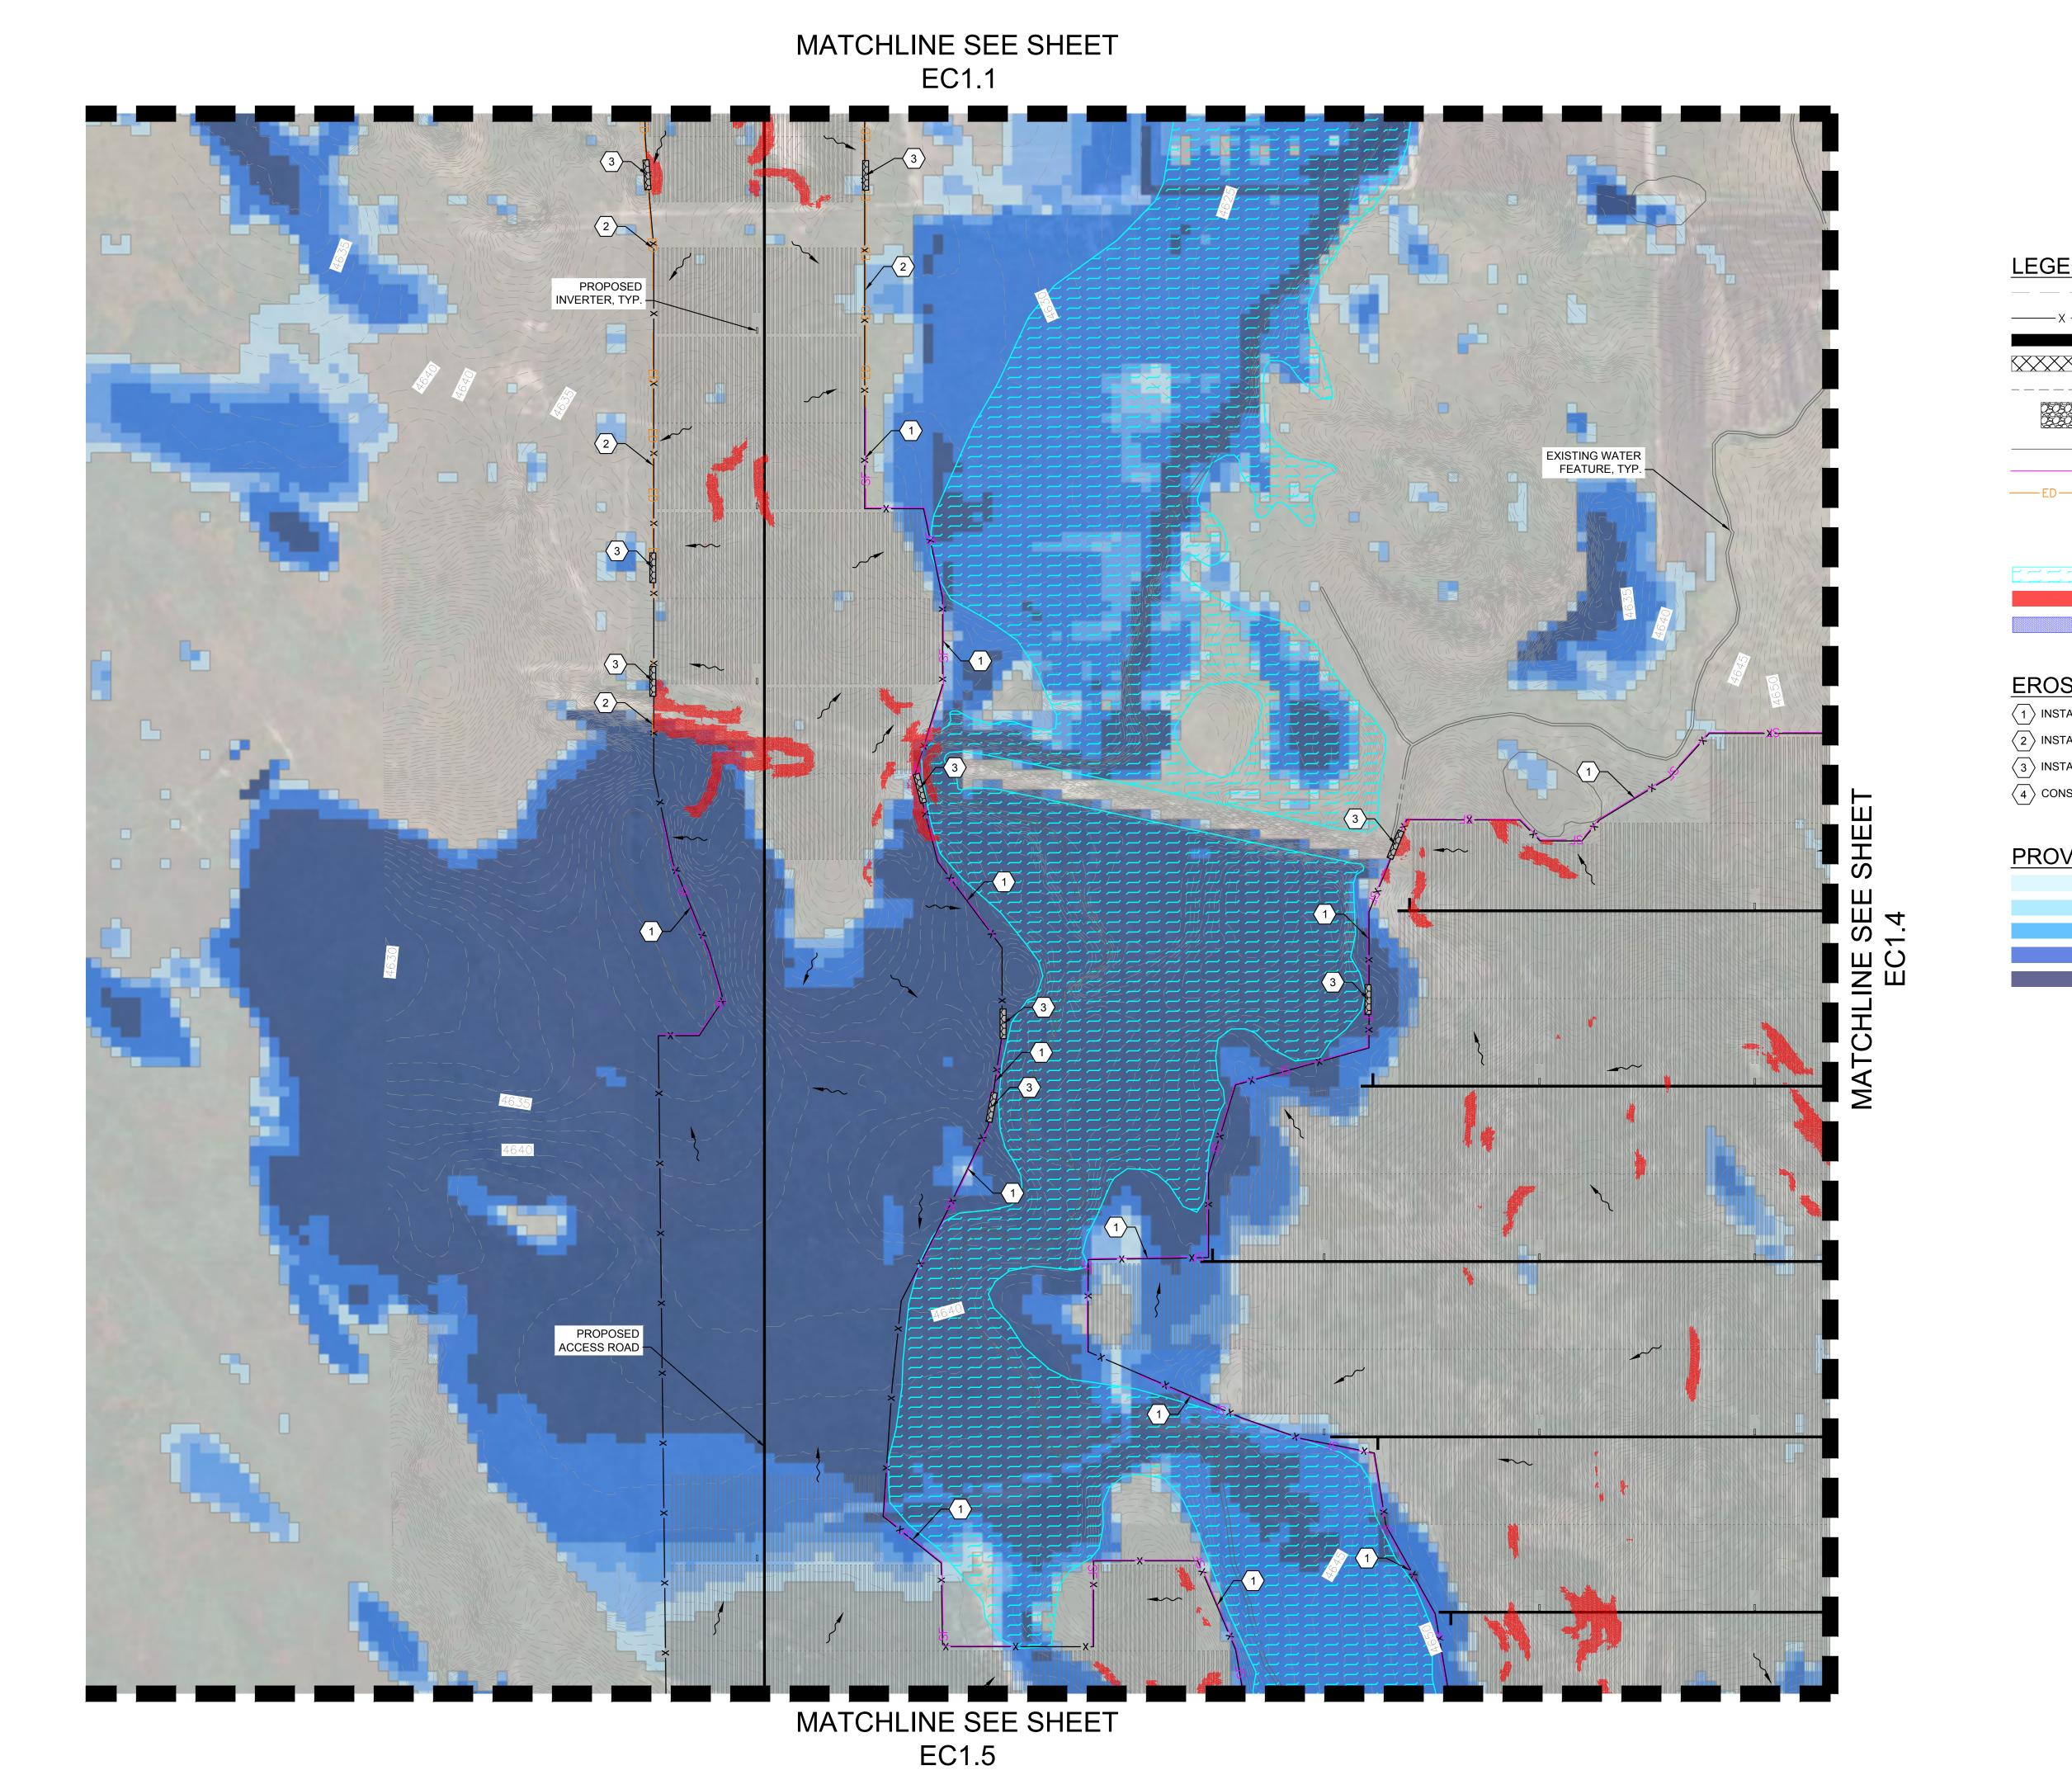

EXISTING GRADE CONTOUR

X X Y PROPOSED SECURITY FENCE

PROPOSED ACCESS ROAD

MATERIALS LAYDOWN AREA

PROPOSED ARRAY BLOCK OUTLINE

PROPOSED VEHICLE TRACKING CONTROL

EXISTING WATER FEATURE

SILT FENCE

EARTH DIKE

ROCK OUTLET

DIRECTION OF STORMWATER FLOW

ZONE A FEMA FLOODPLAIN

PR. INTERNAL EROSION CONTROL AREAS

PR. PERMANENT DETENTION POND

#### **EROSION CONTROL NOTES**

- 1 INSTALL SILT FENCE, SEE DETAIL 1, SHEET EC2.0
- $\langle 2 \rangle$  INSTALL EARTH DIKE, SEE DETAIL 2, SHEET EC2.0
- $\left\langle 3\right\rangle$  INSTALL ROCK OUTLET SEE DETAIL 3, SHEET EC2.0
- 4 CONSTRUCTION ENTRANCE, SEE DETAIL 6, SHEET EC2.0

#### PROVIDED FLOOD DEPTH AND SCOUR (FT)


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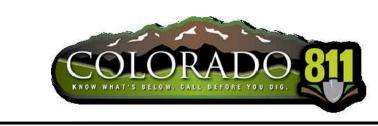
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FLOOD DEPTH (1.50 - 2.00)

FLOOD DEPTH (2.01 - 4.00)

FLOOD DEPTH (4.01+)




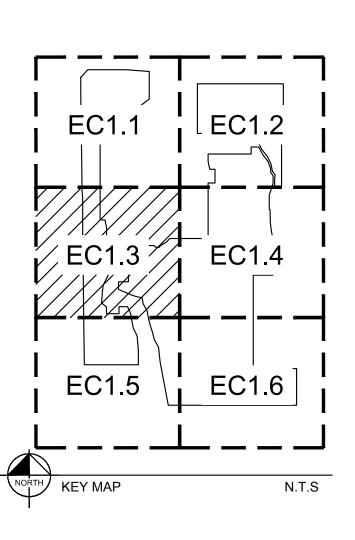


TAELOR SOL PHASE 1 FACILITY

Or

SHEET NUMBER
EC1.3

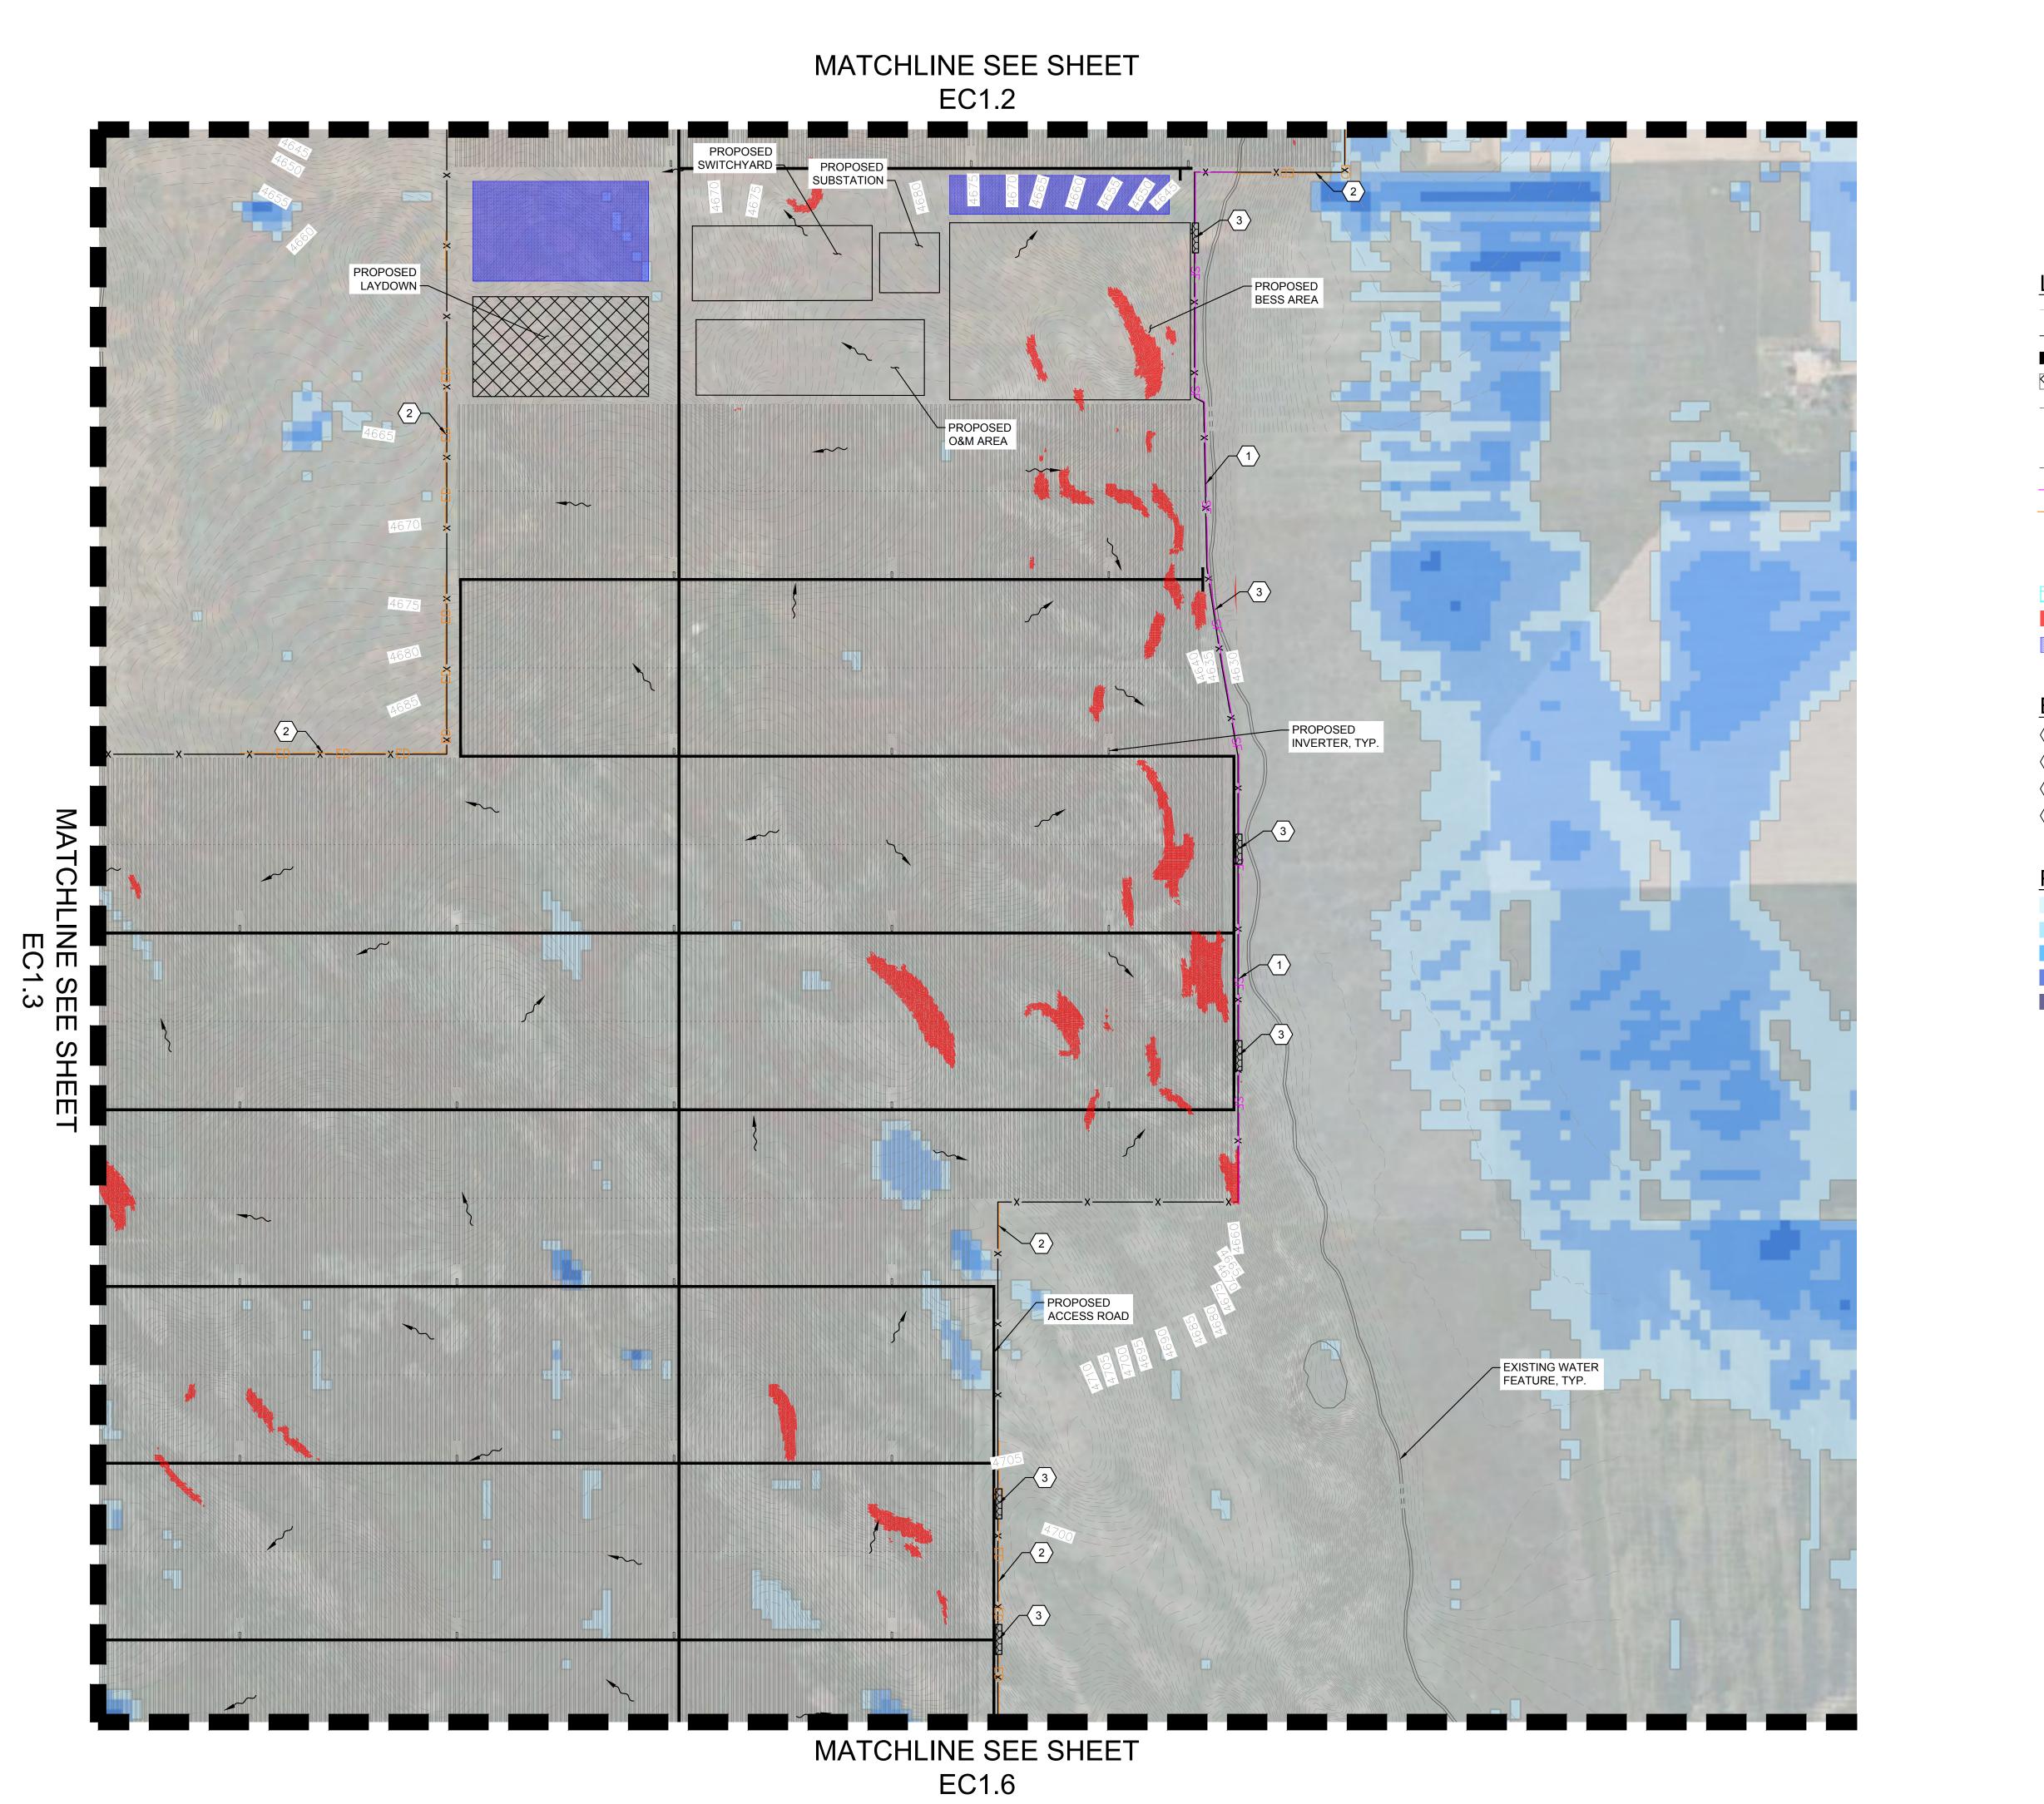

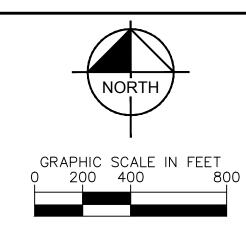

PR. INTERNAL EROSION CONTROL AREAS

PR. PERMANENT DETENTION POND


LEGEND EXISTING GRADE CONTOUR PROPOSED SECURITY FENCE PROPOSED ACCESS ROAD MATERIALS LAYDOWN AREA PROPOSED ARRAY BLOCK OUTLINE PROPOSED VEHICLE TRACKING CONTROL EXISTING WATER FEATURE SILT FENCE EARTH DIKE ROCK OUTLET DIRECTION OF STORMWATER FLOW ZONE A FEMA FLOODPLAIN

#### **EROSION CONTROL NOTES**

- 1 INSTALL SILT FENCE, SEE DETAIL 1, SHEET EC2.0
- $\left\langle 2\right\rangle$  INSTALL EARTH DIKE, SEE DETAIL 2, SHEET EC2.0
- $\boxed{3}$  INSTALL ROCK OUTLET SEE DETAIL 3, SHEET EC2.0
- 4 CONSTRUCTION ENTRANCE, SEE DETAIL 6, SHEET EC2.0

#### PROVIDED FLOOD DEPTH AND SCOUR (FT)


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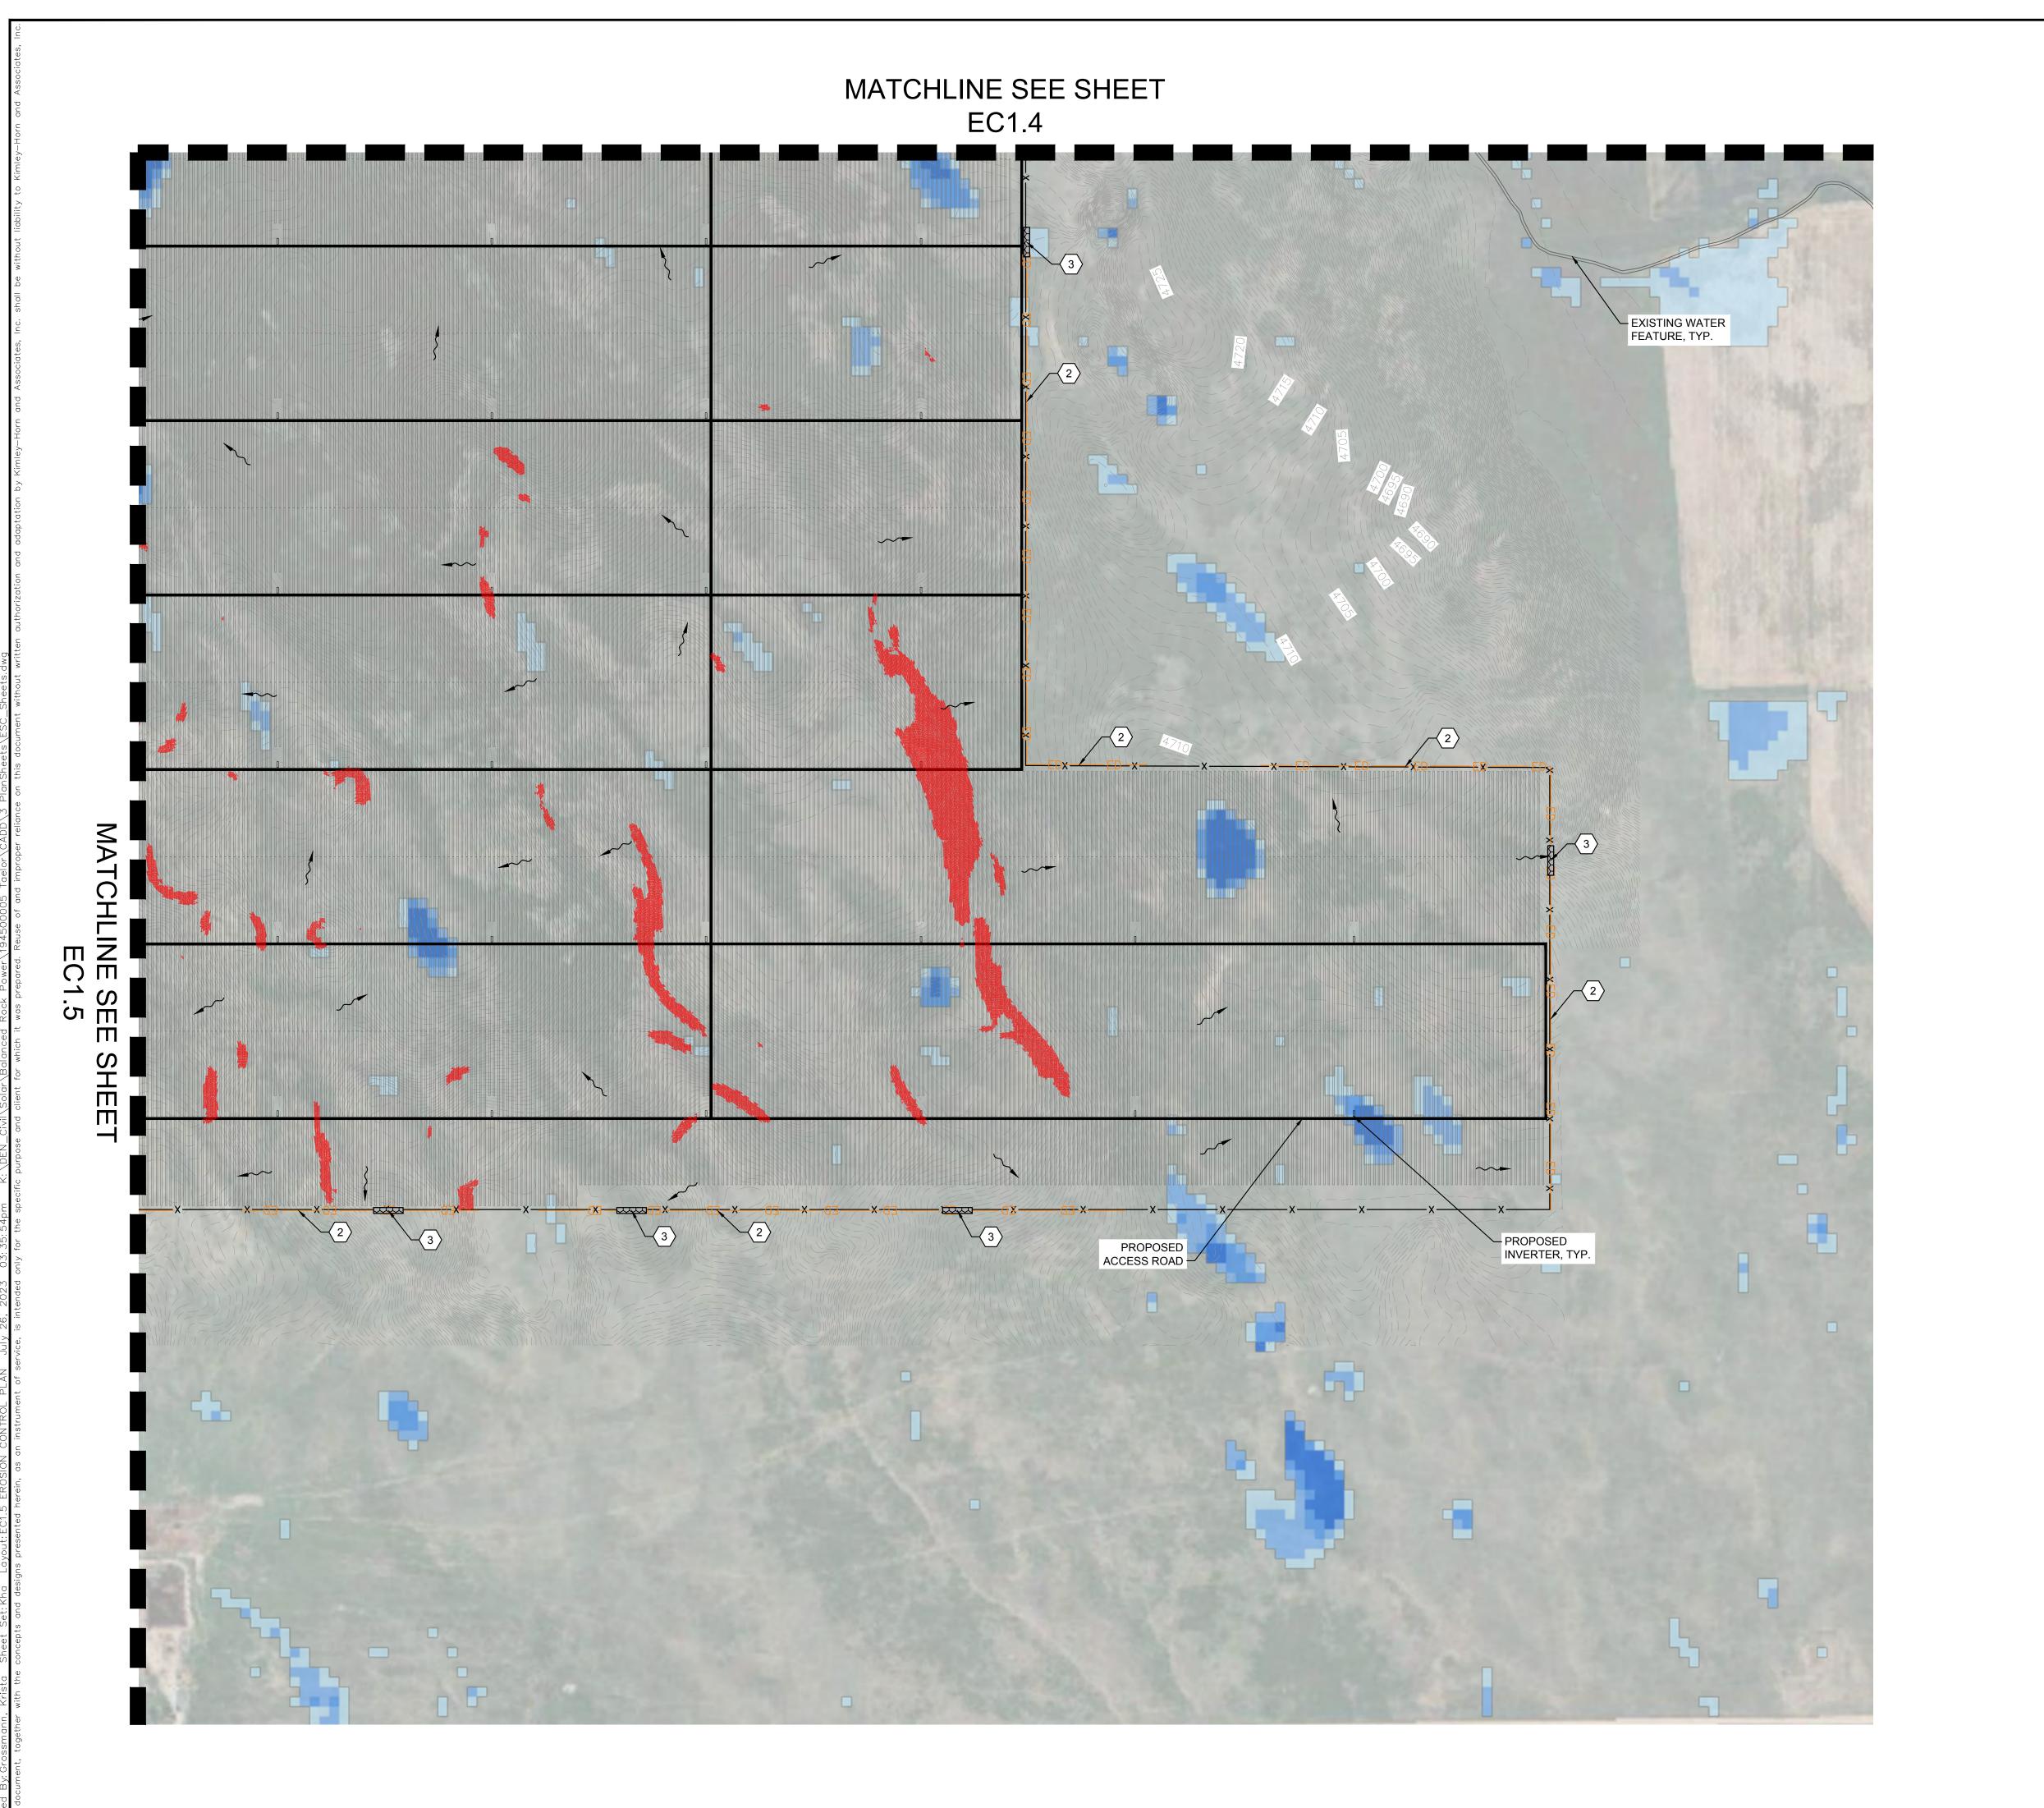


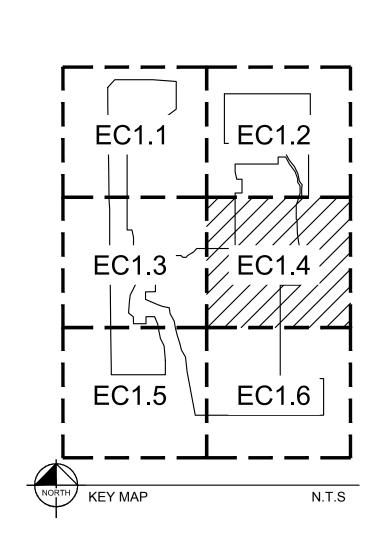


Or

SHEET NUMBER EC1.4



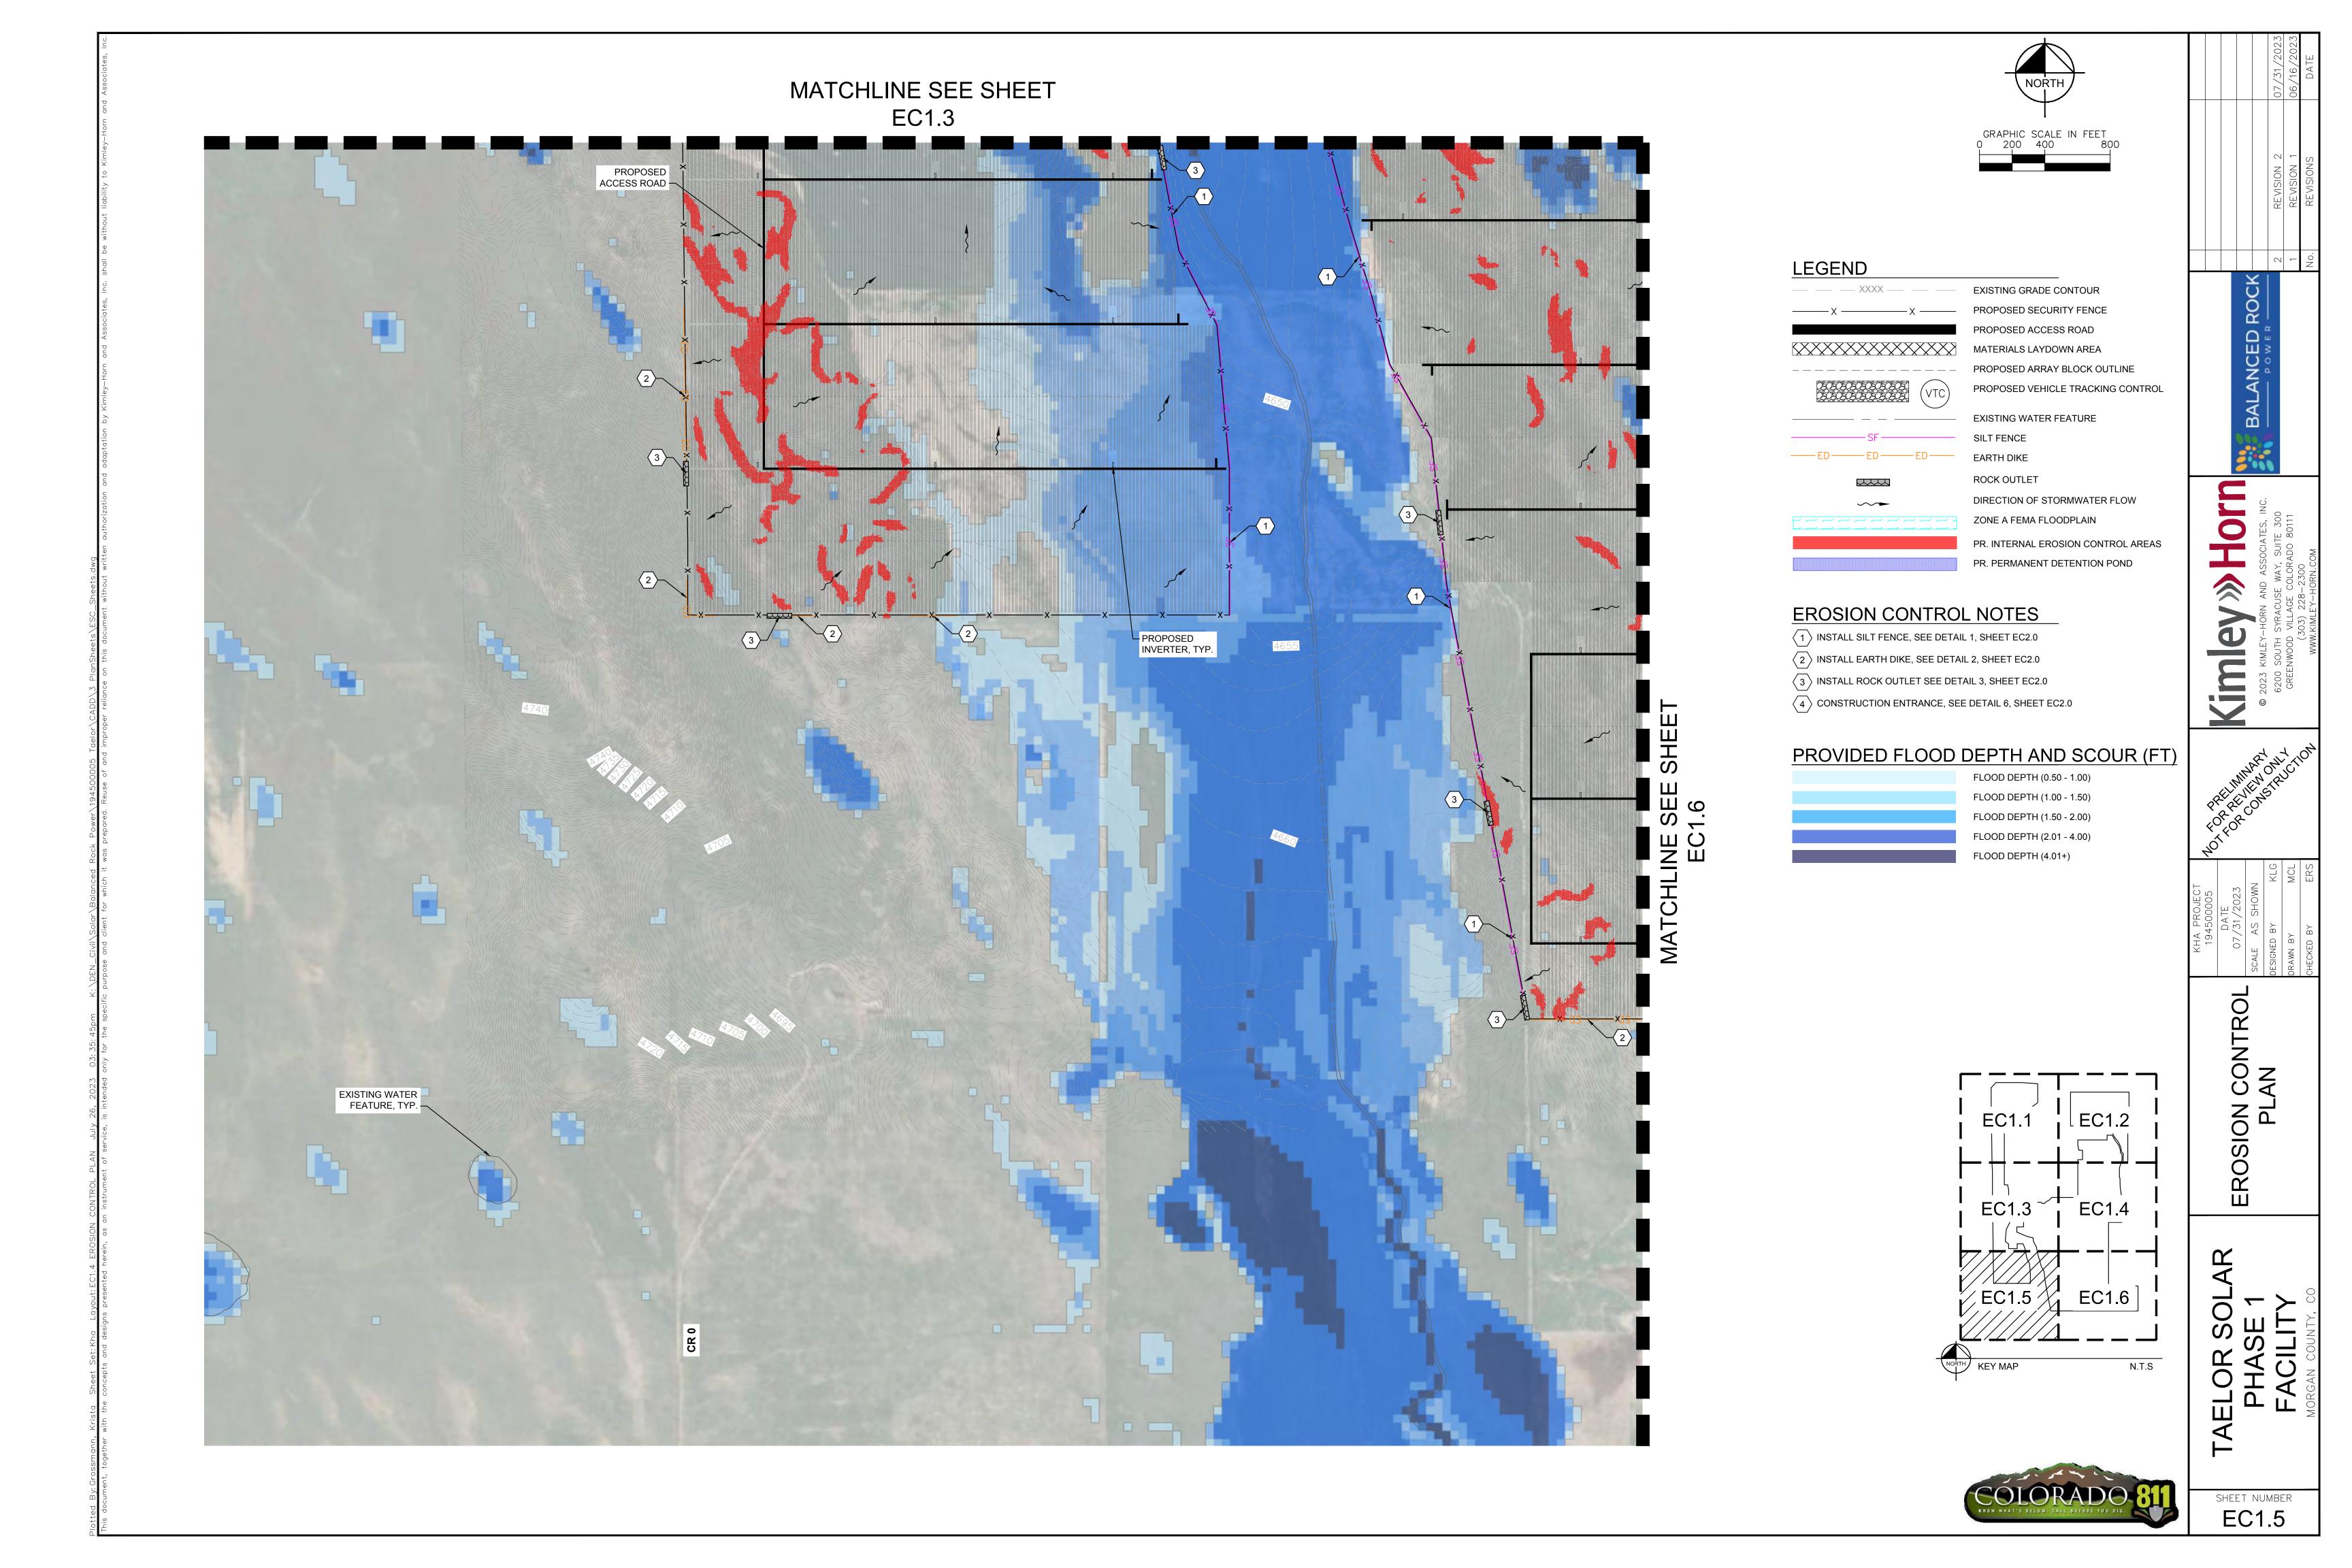

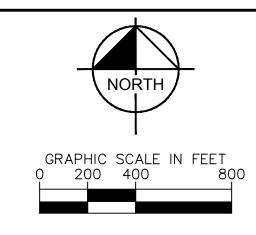

EXISTING GRADE CONTOUR

X X Y PROPOSED SECURITY FENCE

PROPOSED ACCESS ROAD

MATERIALS LAYDOWN AREA

PROPOSED ARRAY BLOCK OUTLINE

PROPOSED VEHICLE TRACKING CONTROL

EXISTING WATER FEATURE

SILT FENCE

EARTH DIKE

ROCK OUTLET

DIRECTION OF STORMWATER FLOW

ZONE A FEMA FLOODPLAIN

PR. INTERNAL EROSION CONTROL AREAS

PR. PERMANENT DETENTION POND

#### **EROSION CONTROL NOTES**

- 1 INSTALL SILT FENCE, SEE DETAIL 1, SHEET EC2.0
- $\left\langle 2 \right\rangle$  INSTALL EARTH DIKE, SEE DETAIL 2, SHEET EC2.0
- $\sqrt{3}$  INSTALL ROCK OUTLET SEE DETAIL 3, SHEET EC2.0
- 4 CONSTRUCTION ENTRANCE, SEE DETAIL 6, SHEET EC2.0

#### PROVIDED FLOOD DEPTH AND SCOUR (FT)


FLOOD DEPTH (0.50 - 1.00)


FLOOD DEPTH (1.00 - 1.50)

FLOOD DEPTH (1.50 - 2.00)

FLOOD DEPTH (2.01 - 4.00)

FLOOD DEPTH (4.01+)

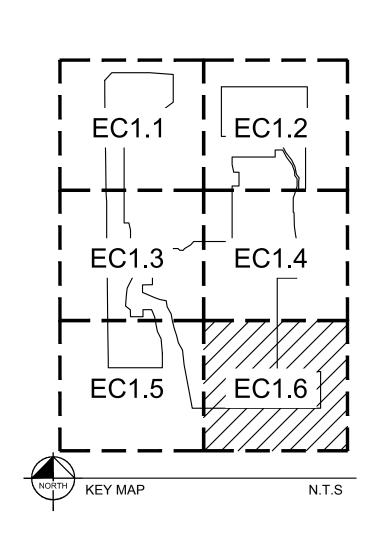

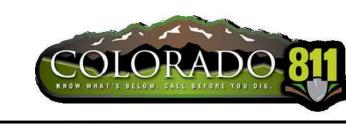



TAELOR SOLAF
PHASE 1
FACILITY

EROSION CONTROL PLAN


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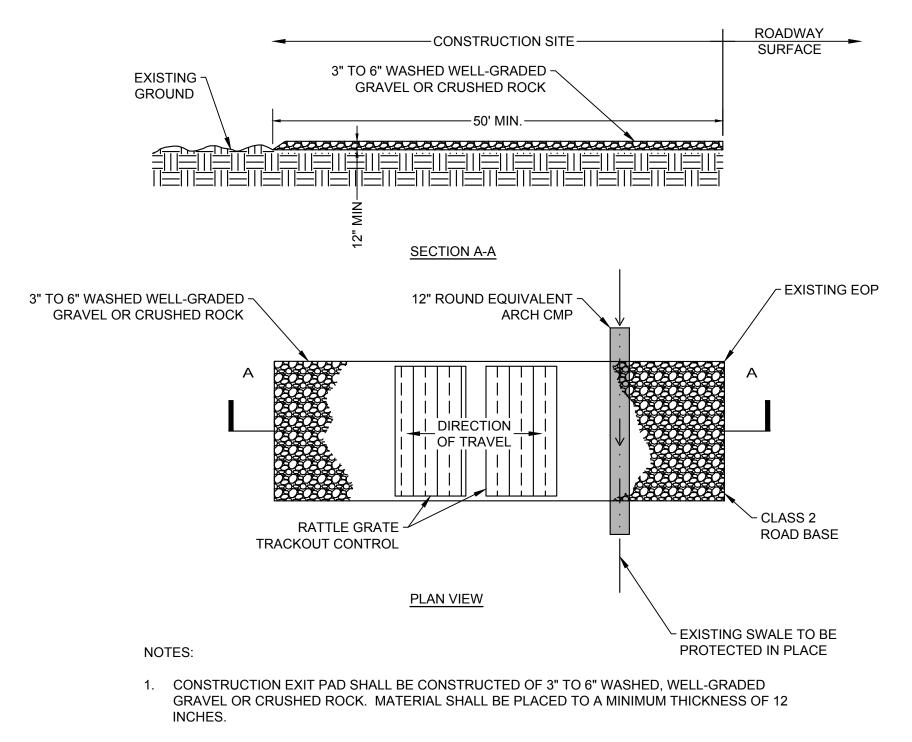
SHEET NUMBER
EC1.6



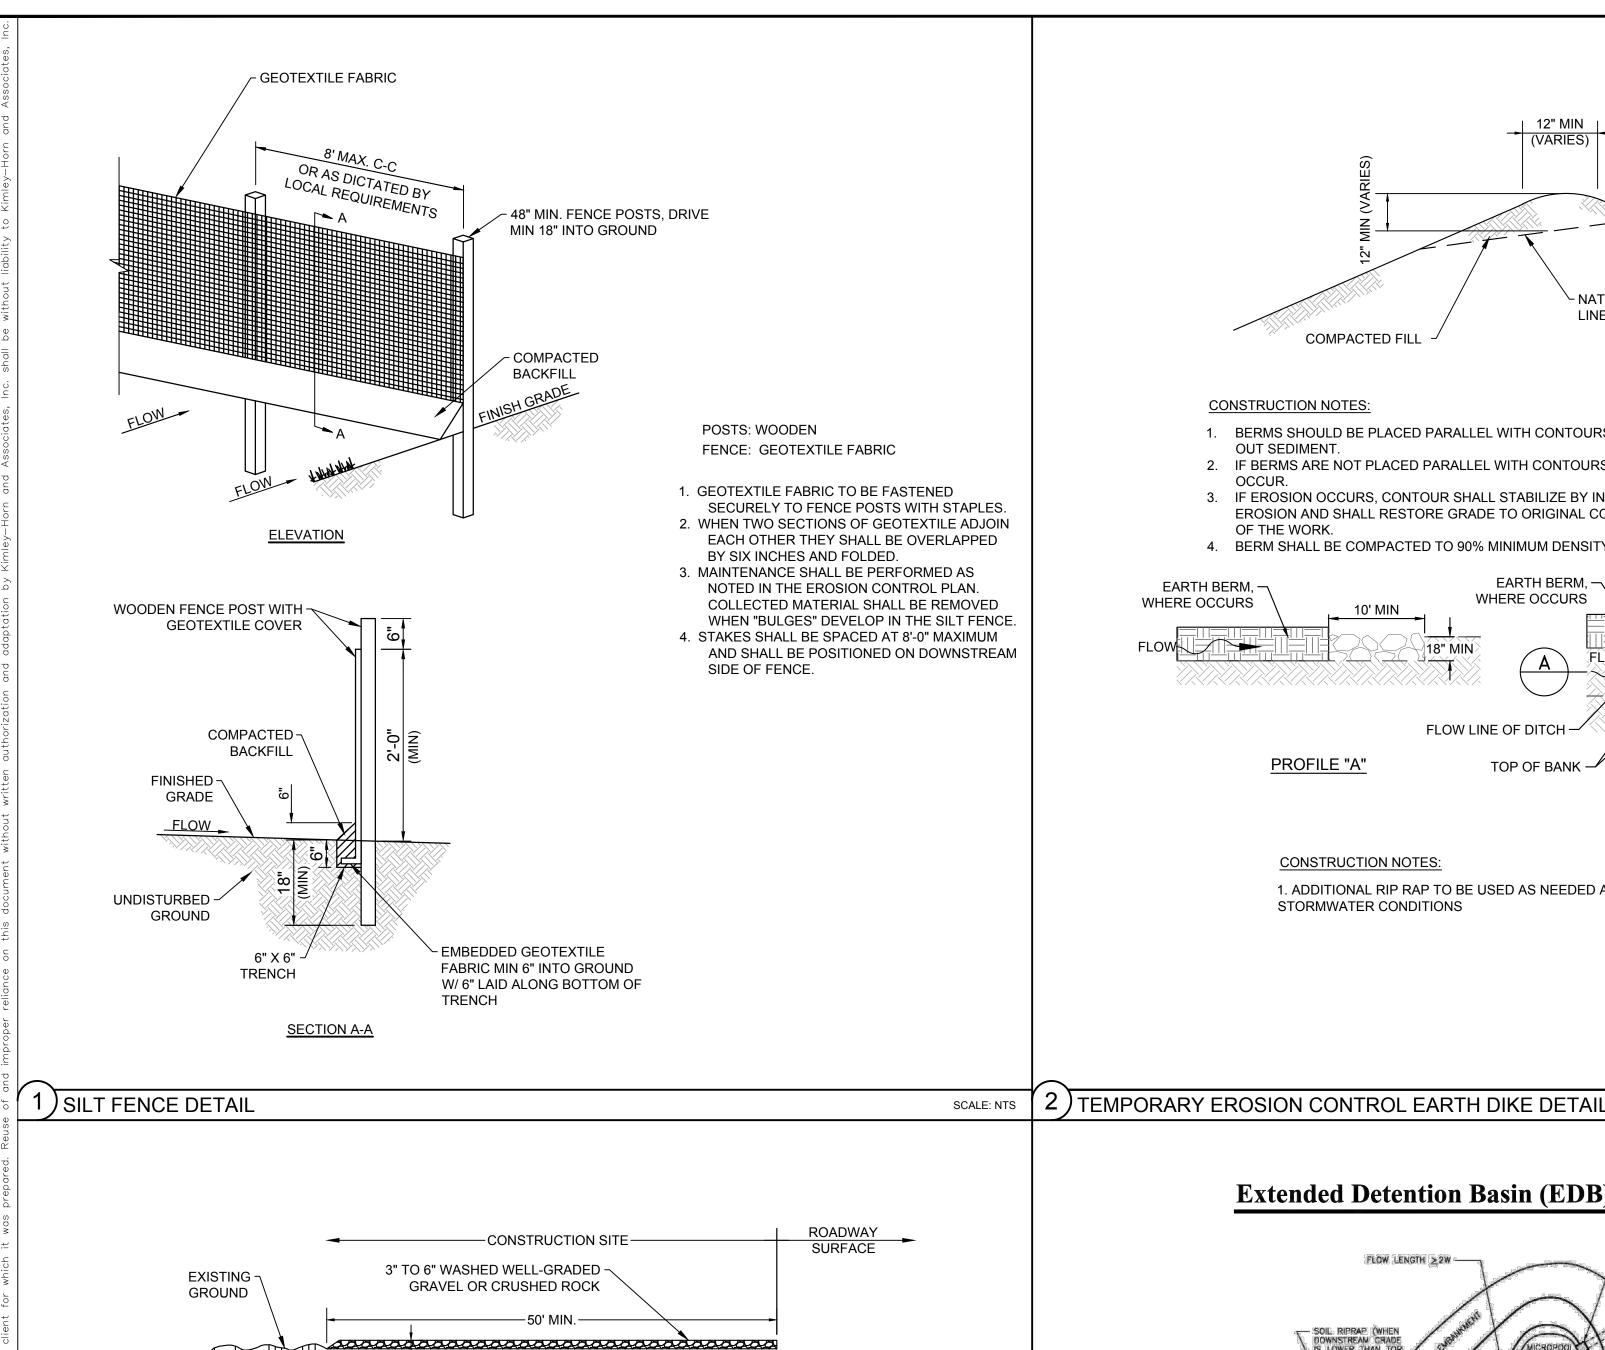

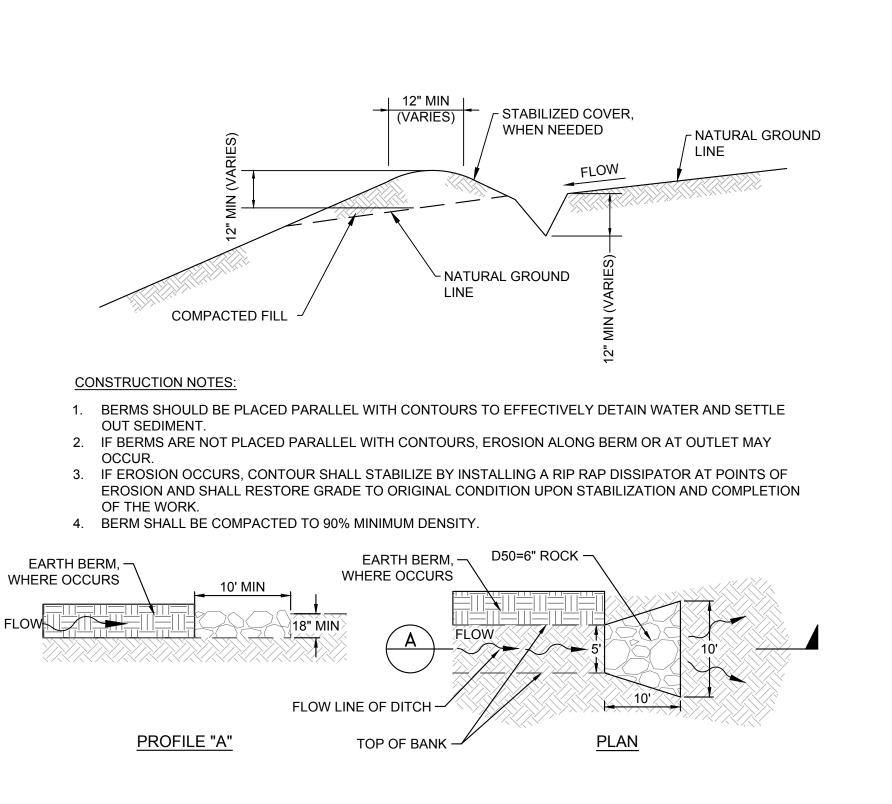1. ADDITIONAL RIP RAP TO BE USED AS NEEDED ACCORDING TO OBSERVED



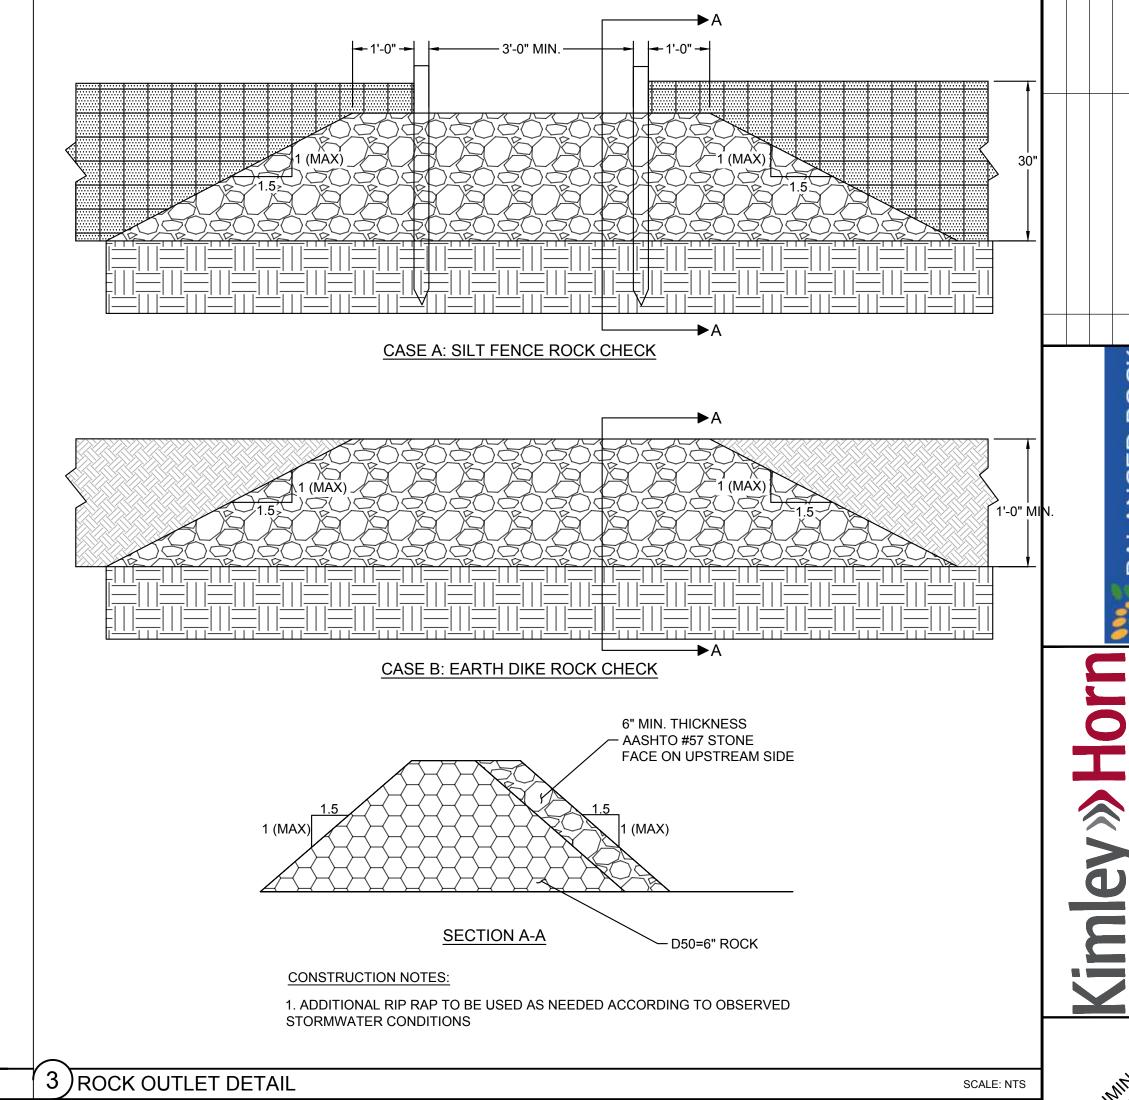

- 2. LENGTH OF CONSTRUCTION EXIT PAD SHALL BE A MINIMUM OF 50 FT. WIDTH SHALL BE A MIN. OF 24 FT OR GREATER IF NECESSARY TO COVER ALL VEHICULAR INGRESS AND EGRESS. PROVIDE AMPLE TURNING RADII.
- 3. THE CONSTRUCTION EXIT PAD SHALL BE KEPT IN GOOD CONDITION BY OCCASIONAL TOP DRESSING WITH MATERIAL AS SPECIFIED IN NOTE 1.
- 4. ACCESSES SHALL BE INSPECTED WEEKLY DURING PERIODS OF HEAVY USAGE, MONTHLY DURING NORMAL USAGE, AND AFTER EACH RAINFALL, WITH MAINTENANCE PROVIDED AS NECESSARY. PERIODIC TOP DRESSING SHALL BE DONE AS NEEDED.

4) CONSTRUCTION ENTRANCE DETAIL

## **Extended Detention Basin (EDB)**

**CONSTRUCTION NOTES:** 

STORMWATER CONDITIONS

**T-5** 

SCALE: NTS

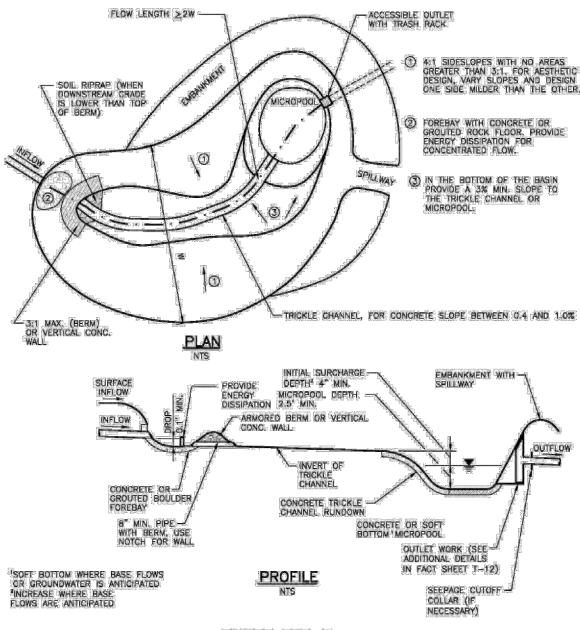


FIGURE EDB-3 EXTENDED DETENTION BASIN

#### Figure EDB-3. Extended Detention Basin (EDB) Plan and Profile


Additional Details are provided in BMP Fact Sheet T-12. This includes outlet structure details including orifice plates and trash racks.

Urban Drainage and Flood Control District December 2010 Urban Storm Drainage Criteria Manual Volume 3

5 ) MHFD EXTENDED DETENTION BASIN DETAIL

**Sediment Basin (SB)** 

SC-7

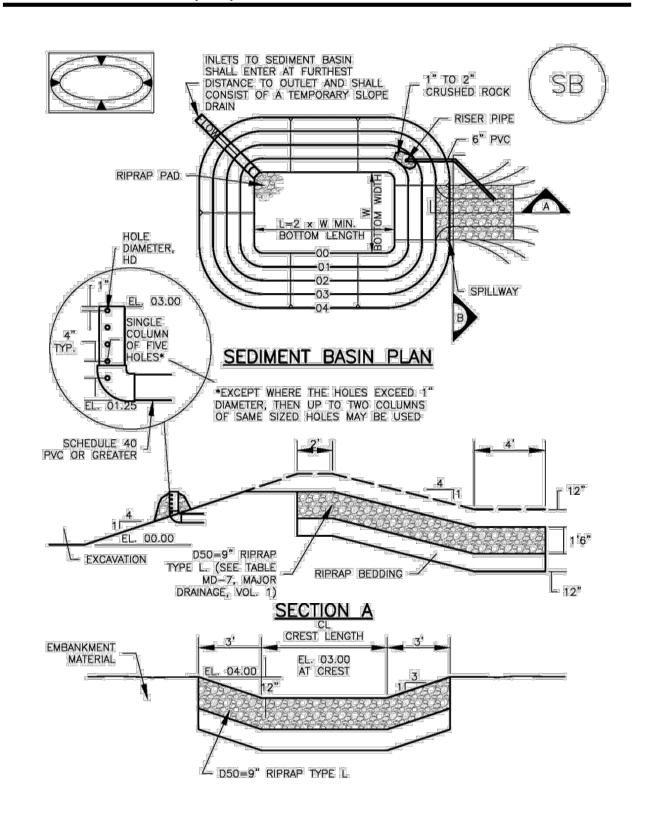

Urban Drainage and Flood Control District August 2013 Urban Storm Drainage Criteria Manual Volume 3

SCALE: NTS

EDB-11

6 MHFD TEMPORARY SEDIMENT BASIN DETAIL

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SHEET NUMBER EC2.0